



US Army Corps
of Engineers
Seattle District



WASHINGTON STATE
DEPARTMENT OF
ECOLOGY

Joint Public Notice

Application for a Department of the Army Permit and
a Washington Department of Ecology Water Quality
Certification and/or Coastal Zone Management
Consistency Concurrence

20 DAY PUBLIC NOTICE

US Army Corps of Engineers
Regulatory Branch
Post Office Box 3755
Seattle, WA 98124-3755
Telephone (360) 764-1171
Attn: Steve Manlow, Project Manager

WA Department of Ecology
SEA Program
Post Office Box 47600
Olympia, WA 98504-7600
Telephone (360) 407-6068
Attn: SEA Program, Federal Permit
Coordinator

Public Notice Date: October 13, 2009
Expiration Date: November 2, 2009
Reference No.: NWS-2007-192-CRS
Name: Skamania County Public Works

Interested parties are hereby notified that the U.S. Army Corps of Engineers (Corps) and the Washington Department of Ecology (Ecology) have received an application to perform work in waters of the United States as described below and shown on the enclosed drawings.

The Corps will review the work in accordance with Section 404 of the Clean Water Act (CWA) and Section 10 of the Rivers and Harbors Act. Ecology will review the work pursuant to Section 401 of the CWA, with applicable provisions of State water pollution control laws.

APPLICANT: Skamania County Public Works
Mr. Larry Douglass
Post Office Box 790
Stevenson Washington 98648
Telephone: (509) 427-3951

LOCATION: The proposed excavation site is located in Rock Creek, and extends from 200 feet upstream of the State Route 14 Bridge to a point approximately 2500 lineal feet upstream, at Stevenson, in Skamania County, Washington. The mitigation site is also located at Stevenson, and consists of 1150 lineal feet of Columbia River shoreline property owned by the Port of Skamania County.

WORK: The applicant is proposing to remove up to 70,000 cubic yards of sediment from approximately 2500 lineal feet of Rock Creek, once per year during low flow periods, for a period of five years. Work will include removal of temporarily stockpiled sediment from previous work from below the ordinary high water line. The work area will be isolated with a cofferdam to minimize sedimentation. The Bonneville Pool elevation will be lowered to reduce water levels in the work area during construction. Mitigation will be provided as described below.

PURPOSE: The project purpose is to protect bridges, other property and infrastructure in Stevenson from flood-related damage caused by sediment accumulation from an extensive landslide upstream of the project site.

ADDITIONAL INFORMATION: In 2006, Skamania County identified a hazardous landslide area approximately 1 mile upstream of the Rock Creek Drive Bridge in Stevenson, resulting in deposition of between 500,000 and 1,000,000 cubic yards of material into Rock Creek. In response to a request from Skamania County, the District Engineer initiated emergency authorization procedures as outlined in 33 CFR 325.2(e)(4). On February 12, 2007 the Corps allowed the removal of accreted sediments from a 1,500 lineal foot segment of Rock Creek. On April 19, 2007, the Corps and Department of Ecology (Ecology) issued a Joint Public Notice addressing the completed work, in addition to a proposal to remove an additional 50,000 cubic yards of sediment as needed to maintain channel capacity. On June 14, 2007, Skamania County also submitted a request for authorization to install 80 steel pile and 48 brace logs for construction of 16 large wood trap structures, to store sediment upstream of the Rock Creek Drive Bridge. A public notice was issued for this proposal on September 6, 2007. Skamania County subsequently modified their excavation proposal to include removal of up to 70,000 cubic yards of sediment, instead of the originally proposed 50,000 cubic yards. In response to increased sediment deposition, on September 13, 2007 Skamania County submitted another emergency request for removal of 70,000 cubic yards of sediment and installation of the proposed wood trap structures described above. On September 17, 2007, the Corps allowed the removal of this material. A total of approximately 153,500 cubic yards of material was removed from Rock Creek during the two emergency excavation projects in 2007. Since that time, sediment has again accreted in the project reach, including the area upstream of and surrounding the wood trap structures, as a result of the upstream landslide movement. The current proposal is intended to restore channel capacity to reduce the potential for damage to public and private infrastructure.

Copies of this public notice which have been mailed or otherwise physically distributed feature project drawings in black and white. The electronic version features those drawings in color, which we think more accurately communicates the scope of project impacts. To access the electronic version of this public notice, go to the Seattle District's web page at <http://www.nws.usace.army.mil/> and scroll down the alphabetical listing of District elements, and click on "Regulatory" and then "Regulatory – Permits" for the Seattle District's Regulatory homepage. Select the prominently displayed "Public Notices" heading and a list of recently-issued public notices will appear, in chronological order of the date of issuance. Select and view the listing for this project.

MITIGATION: Large woody debris removed from Rock Creek during sediment excavation will be placed behind existing debris traps and deflector pilings and cabled in place, as mitigation for project impacts. Mitigation will also include removal of 125 lineal feet of steel sheet pile and 600 lineal feet of rock riprap from the Columbia River, and restoration of 1,150 lineal feet of shoreline by placement of sediment and large woody debris excavated from Rock Creek and establishment native vegetation.

ENDANGERED SPECIES: The Endangered Species Act (ESA) requires federal agencies to consult with the National Marine Fisheries Service (NMFS) and/or U.S. Fish and Wildlife Service (USFWS) pursuant to Section 7 of ESA on all actions that may affect a species listed (or proposed for listing) under the ESA as threatened or endangered or any designated critical habitat. The Corps submitted a Biological Assessment (BA) to the NMFS, and a Biological Opinion (BO) was issued on August 3, 2009.

ESSENTIAL FISH HABITAT: The Magnuson-Stevens Fishery Conservation and Management Act, as amended by the Sustainable Fisheries Act of 1996, requires all Federal agencies to consult with the NMFS on all actions, or proposed actions, permitted, funded, or undertaken by the agency, that may adversely affect Essential Fish Habitat (EFH). The August 3, 2009 BO described above also addresses potential impacts to EFH.

CULTURAL RESOURCES: The District Engineer has reviewed the latest published version of the National Register of Historic Places, lists of properties determined eligible and other sources of information. There are no recorded historic properties within the permit area. The permit area has been so extensively modified by modern development that little likelihood exists for the proposed project to impinge upon an undisturbed historic property. The District Engineer invites responses to this public notice from Native American Nations or tribal governments; Federal, State, and local agencies; historical and archeological societies; and other parties likely to have knowledge

of or concerns with historic properties in the area. This public notice initiates consultation under Section 106 of the National Historic Preservation Act (36 CFR 800.4[a][3]), with any Tribe that has information or concerns with historic properties in the proposed permit area.

PUBLIC HEARING: Any person may request, in writing, within the comment period specified in this notice, that a public hearing be held to consider this application. Requests for public hearings shall state, with particularity, the reasons for holding a public hearing.

EVALUATION – CORPS - The decision whether to issue a permit will be based on an evaluation of the probable impacts, including cumulative impacts, of the proposed activity on the public interest. That decision will reflect the national concern for both protection and utilization of important resources. The benefits, which reasonably may be expected to accrue from the proposal, must be balanced against its reasonably foreseeable detriments. All factors which may be relevant to the proposal will be considered, including the cumulative effects thereof; among those are conservation, economics, aesthetics, general environmental concerns, wetlands, historic properties, fish and wildlife values, flood hazards, floodplain values, land use, navigation, shoreline erosion and accretion, recreation, water supply and conservation, water quality, energy needs, safety, food and fiber production, mineral needs, considerations of property ownership, and, in general, the needs and welfare of the people.

The Corps is soliciting comments from the public; Native American Nations or tribal governments; Federal, State, and local agencies and officials; and other interested parties in order to consider and evaluate the impacts of this activity. Any comments received will be considered by the Corps to determine whether to issue, modify, condition or deny a permit for the work. To make this decision, comments are used to assess impacts on endangered species, historic properties, water quality, general environmental effects, and the other public interest factors listed above. Comments are used in the preparation of an Environmental Assessment and/or an Environmental Impact Statement pursuant to the National Environmental Policy Act. Comments are also used to determine the need for a public hearing and to determine the overall public interest of the activity.

EVALUATION—ECOLOGY: Ecology is soliciting comments from the public; Federal, Native American Nations or tribal governments, State, and local agencies and officials; and other interested parties in order to consider and evaluate the impacts of this activity. Ecology will be considering all comments to determine whether to certify or deny certification for the proposed project. The City of Stevenson has issued an exemption from the requirement of obtaining a Shorelines Substantial Development permit for this project.

COMMENT AND REVIEW PERIOD: Conventional mail or e-mail comments on this public notice will be accepted and made part of the record and will be considered in determining whether it would be in the public interest to authorize this proposal. In order to be accepted, e-mail comments must originate from the author's e-mail account and must include on the subject line of the e-mail message the permit applicant's name and reference number as shown below. Either conventional mail or e-mail comments must include the permit applicant's name and reference number, as shown below, and the commentator's name, address, and phone number. All comments whether conventional mail or e-mail must reach this office, no later than the expiration date of this public notice to ensure consideration.



Corps comments: All e-mail comments should be sent to Steven.W.Manlow@usace.army.mil. Conventional mail comments should be sent to U.S. Army Corps of Engineers, Regulatory Branch, Attn: Steve Manlow, Post Office Box 3755, Seattle, Washington, 98124-3755.

Ecology Comments: Any person desiring to present views on the project pertaining to a request for water quality certification under Section 401 of the CWA may do so by submitting written comments to the following address: Department of Ecology, Attn: SEA program – Federal Permit Coordinator, P.O. Box 47600, Olympia, Washington, 98504-7600, or e-mail to ecyrefedpermits@ecy.wa.gov

NWS-2007-192-CRS

To ensure proper consideration of all comments, responders must include the following name and reference number in the text of their comments: **Skamania County Public Works, NWS-2007-192-CRS.**

Encl: Excavation Project Plans Sheets 1 through 9; Stevenson Enhancement Project Sheets 1 through 14, and 1 through 2 (typicals).

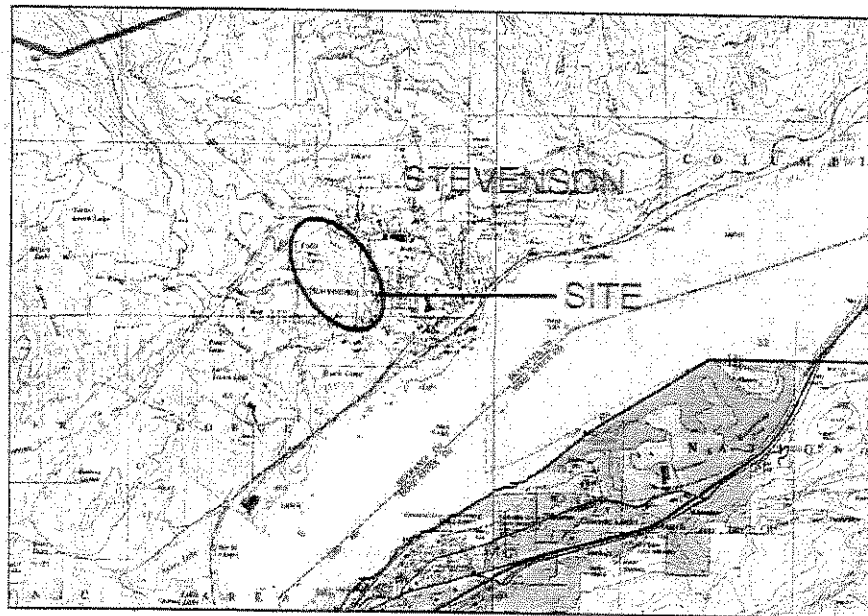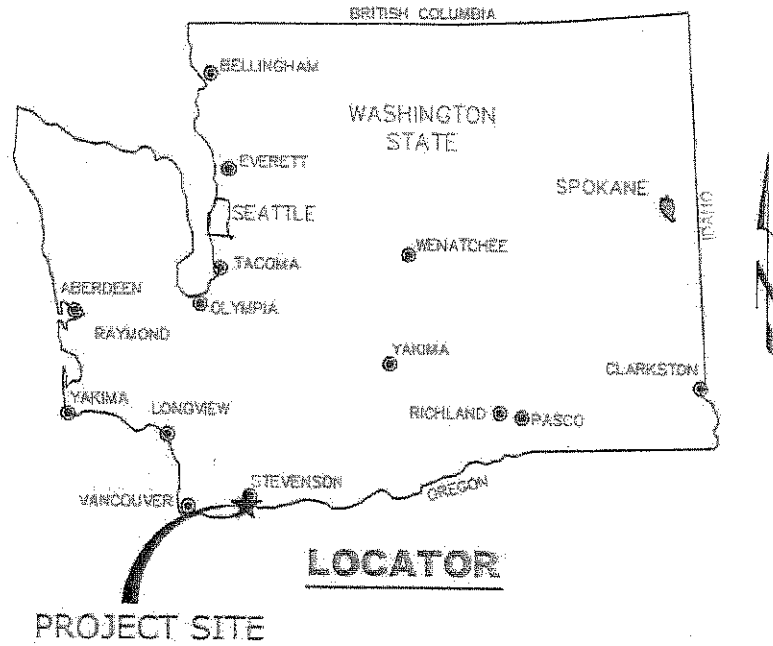

SE 1/4 Section 36, Township 03 North, Range 07 East, W.M.
 NE 1/4 and NW 1/4, Section 01, Township 02 North, Range 07 East, W.M.
 Latitude: 45.69362 Longitude: -121.89219
 Skamania County

COE REF# 2007-192

SHEET:

LOCATOR MAP

DATE:

Flowing solutions



Flowing Solutions
 3305 SW 87th Avenue
 Portland, OR 97225
 Phone (503) 297-6311
 Fax: (503) 297-6055

PROJECT: Rock Creek Dredge 2009
 Skamania County Public Works
 P.O. Box 790, Stevenson, WA 98648

9/3/09


RIVER/MILE: Rock Creek, RM 1-2


DATUM: NGVD

SHEET NO.


1/9

d:\projects\rockcreekdredge\rockcreekdredge2009 - coepermit.dwg

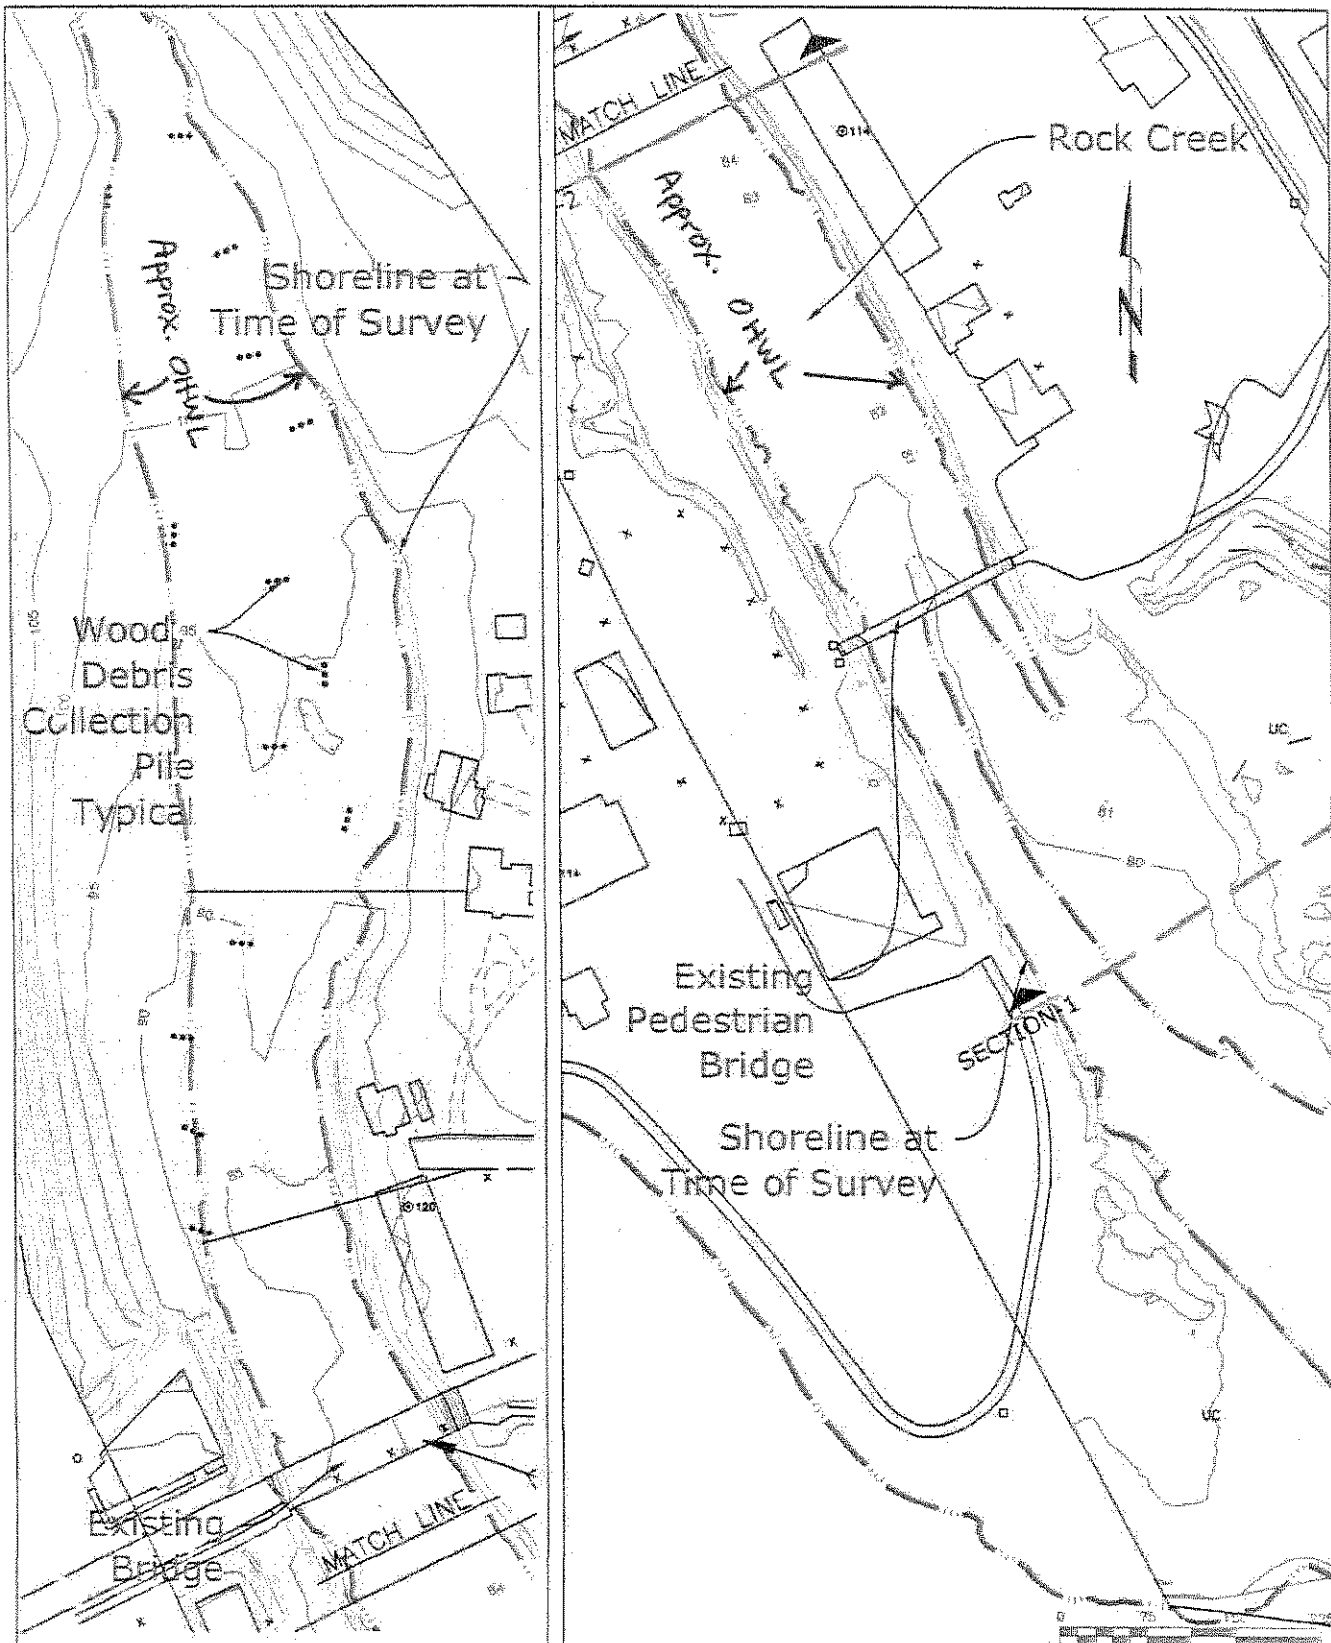

COE REF# 2007-192	SHEET: EXISTING SURVEY -2007	DATE: 9/3/09
Flowing solutions  Flowing Solutions 3305 SW 87th Avenue Portland, OR 97225 Phone (503) 297-6311 Fax (503) 297-6053	PROJECT: Rock Creek Dredge 2009 Skamania County Public Works P.O. Box 790, Stevenson, WA 98648	SHEET NO. 2/9
RIVER/MILE: Rock Creek, RM 1-2	DATUM: NGVD	

d:\s\projects\rockcreekdredge\rockcreekdredge2009-coepermit.dwg

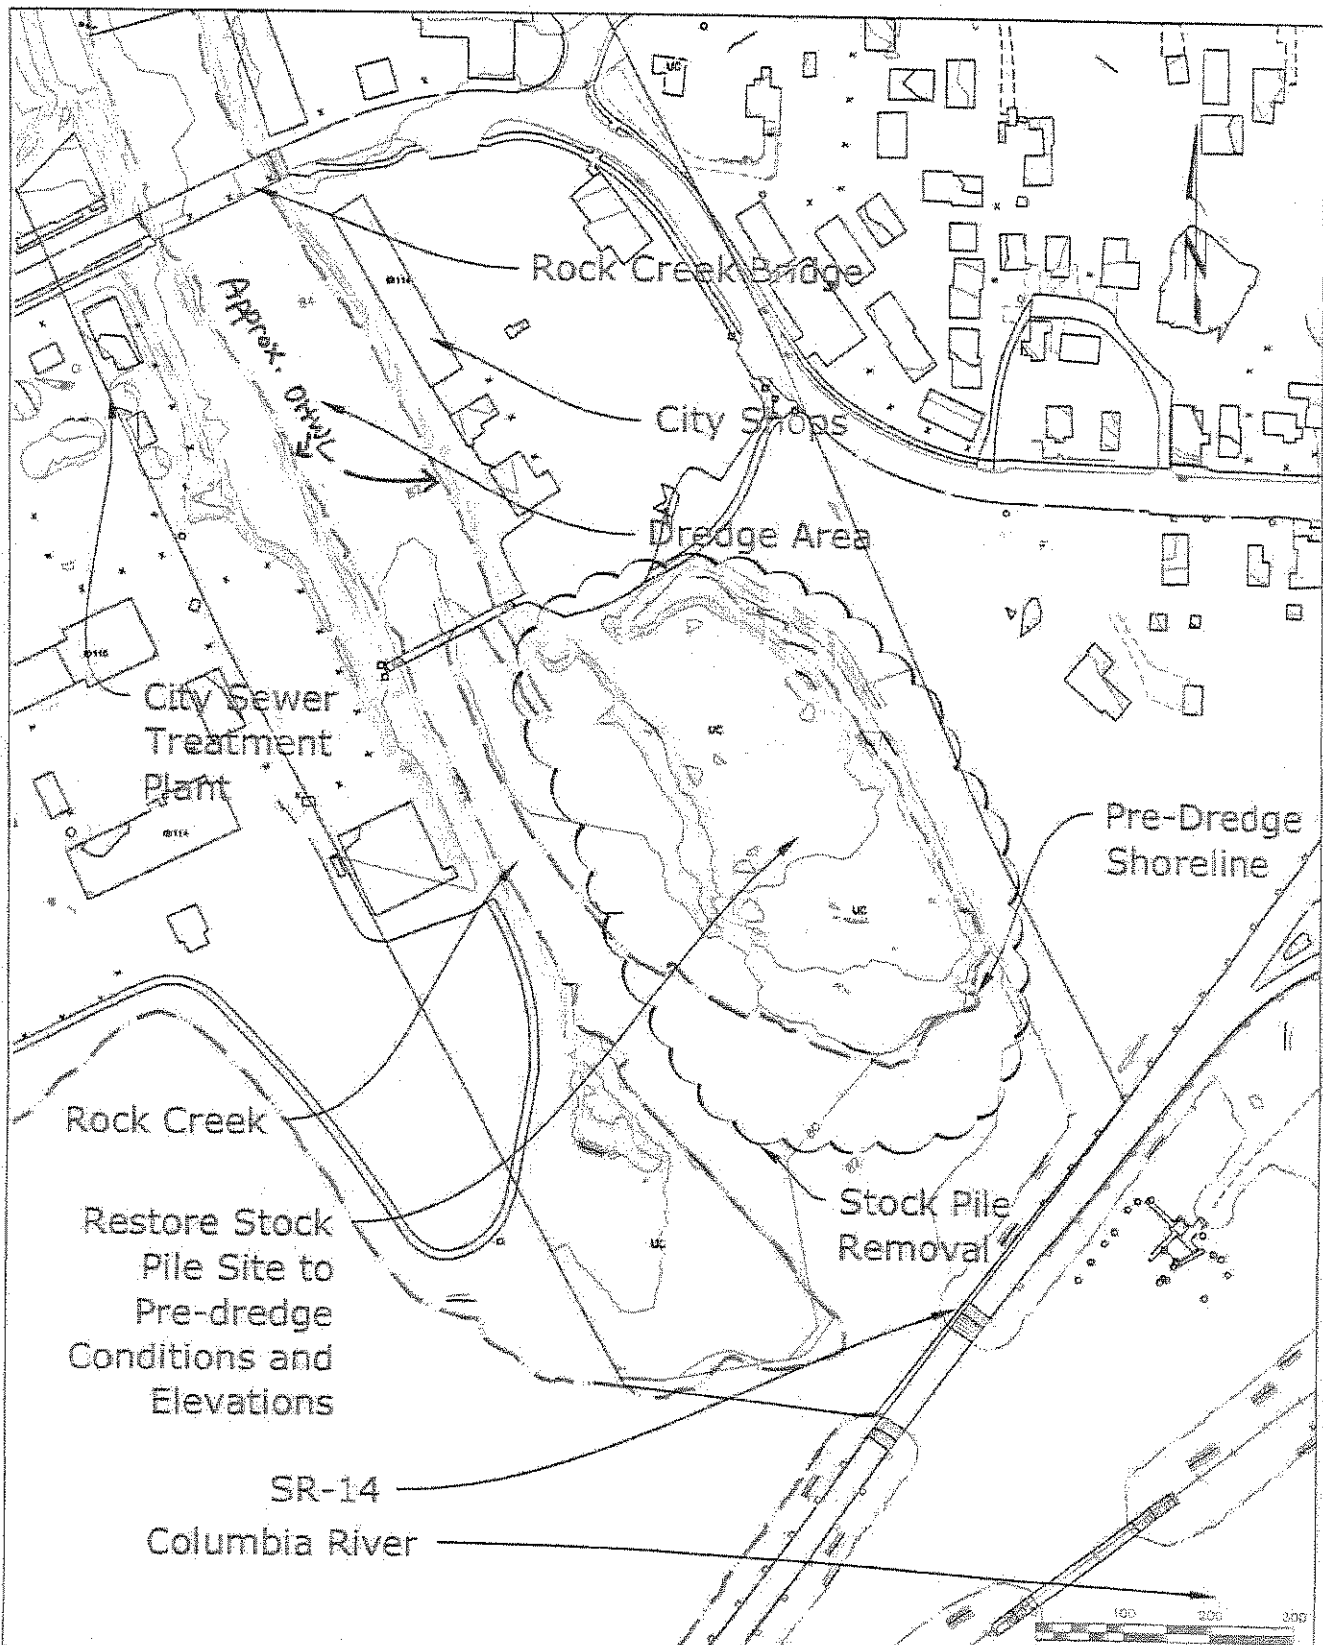

COE REF# 2007-192

SHEET:

STOCK PILE - 2007

DATE:

Flowing solutions



Flowing Solutions
3305 SW 87th Avenue
Portland, OR 97225
Phone (503) 297-6311
Fax (503) 297-6053

PROJECT:

Rock Creek Dredge 2009
Skamania County Public Works
P.O. Box 790, Stevenson, WA 98648

9/3/09


SHEET NO.


RIVER/MILE: Rock Creek, RM 1-2

DATUM: NGVD


3/9


d:\fs\projects\rockcreekdredge\rockcreekdredge2009-coopermit.dwg

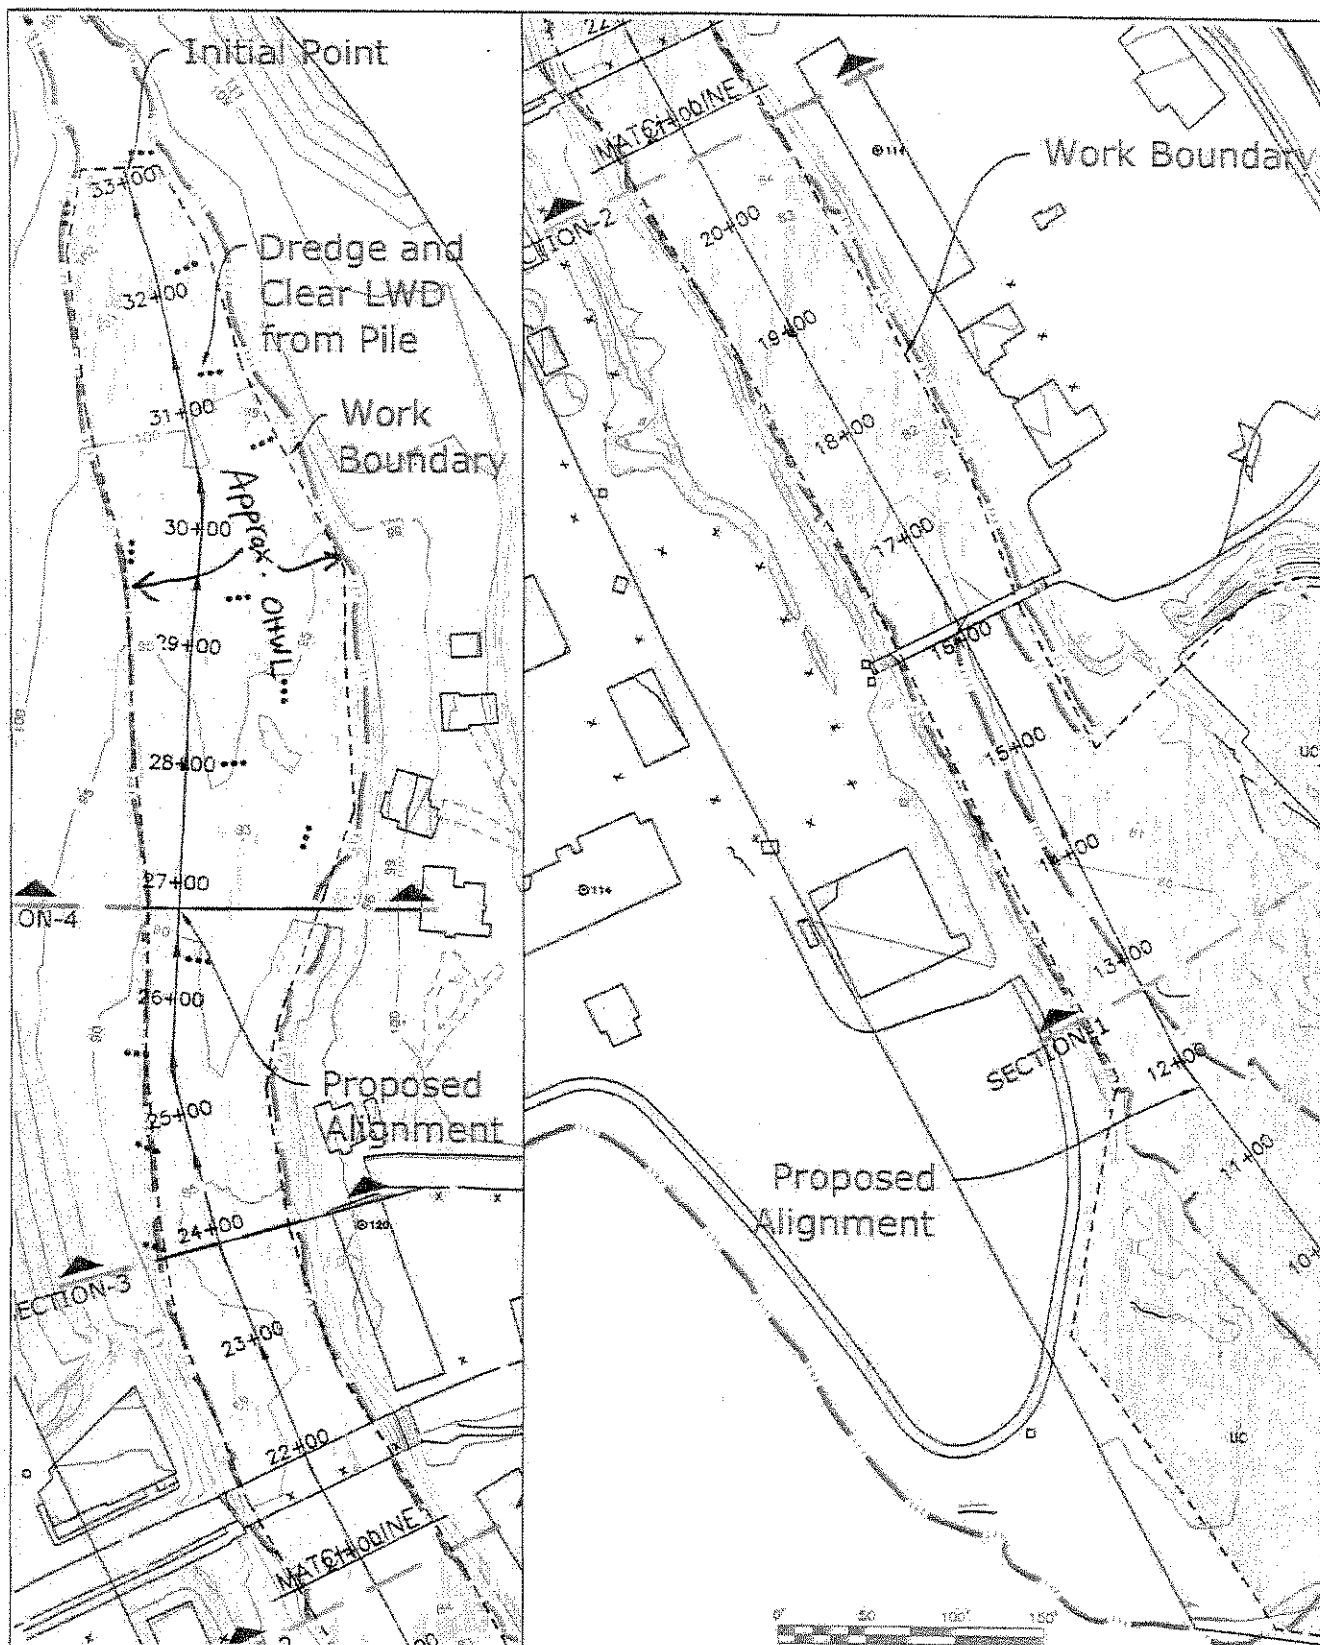


COE REF# 2007-192	SHEET: PROPOSED DREDGE ALIGNMENT	DATE:
 Flowing solutions Flowing Solutions 3305 SW 87th Avenue Portland, OR 97225 Phone (503) 287-6311 Fax (503) 287-8053	PROJECT: Rock Creek Dredge 2009 Skamania County Public Works P.O. Box 790, Stevenson, WA 98648	9/3/09
	RIVER/MILE: Rock Creek, RM 1-2	SHEET NO. 4/9 DATUM: NGVD

d:\projects\rockcreekdredge\rockcreekdredge2009-coepermit.dwg

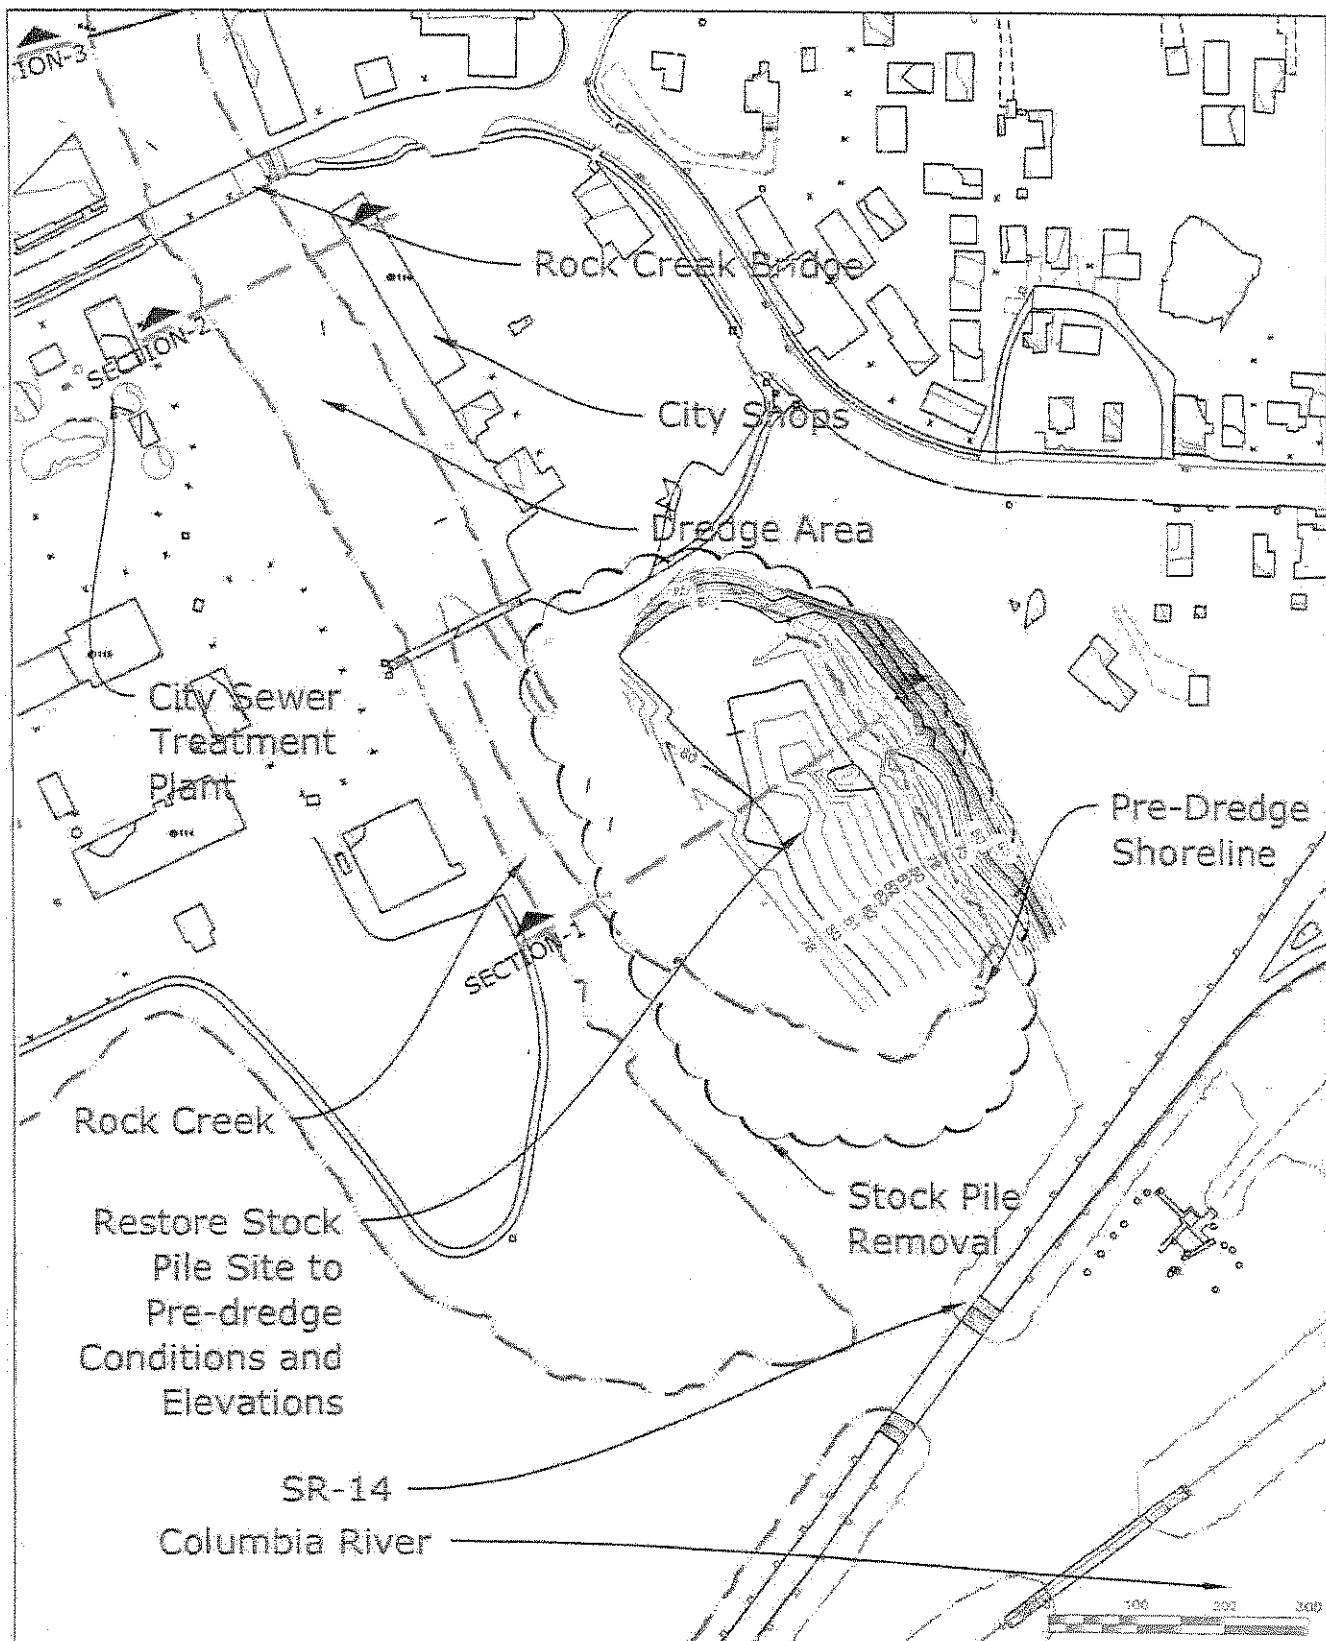


COE REF# 2007-192	SHEET: STOCK PILE - PROPOSED REMOVAL	DATE: 9/3/09
Flowing solutions  Flowing Solutions 3305 SW 67th Avenue Portland, OR 97225 Phone: (503) 297-6311 Fax: (503) 297-6053	PROJECT: Rock Creek Dredge 2009 Skamania County Public Works P.O. Box 790, Stevenson, WA 98648	SHEET NO. 5/9
	RIVER/MILE: Rock Creek, RM 1-2	DATUM: NGVD

d:\fs\projects\rockcreekdredge\rockcreekdredge2009-coepermit.dwg

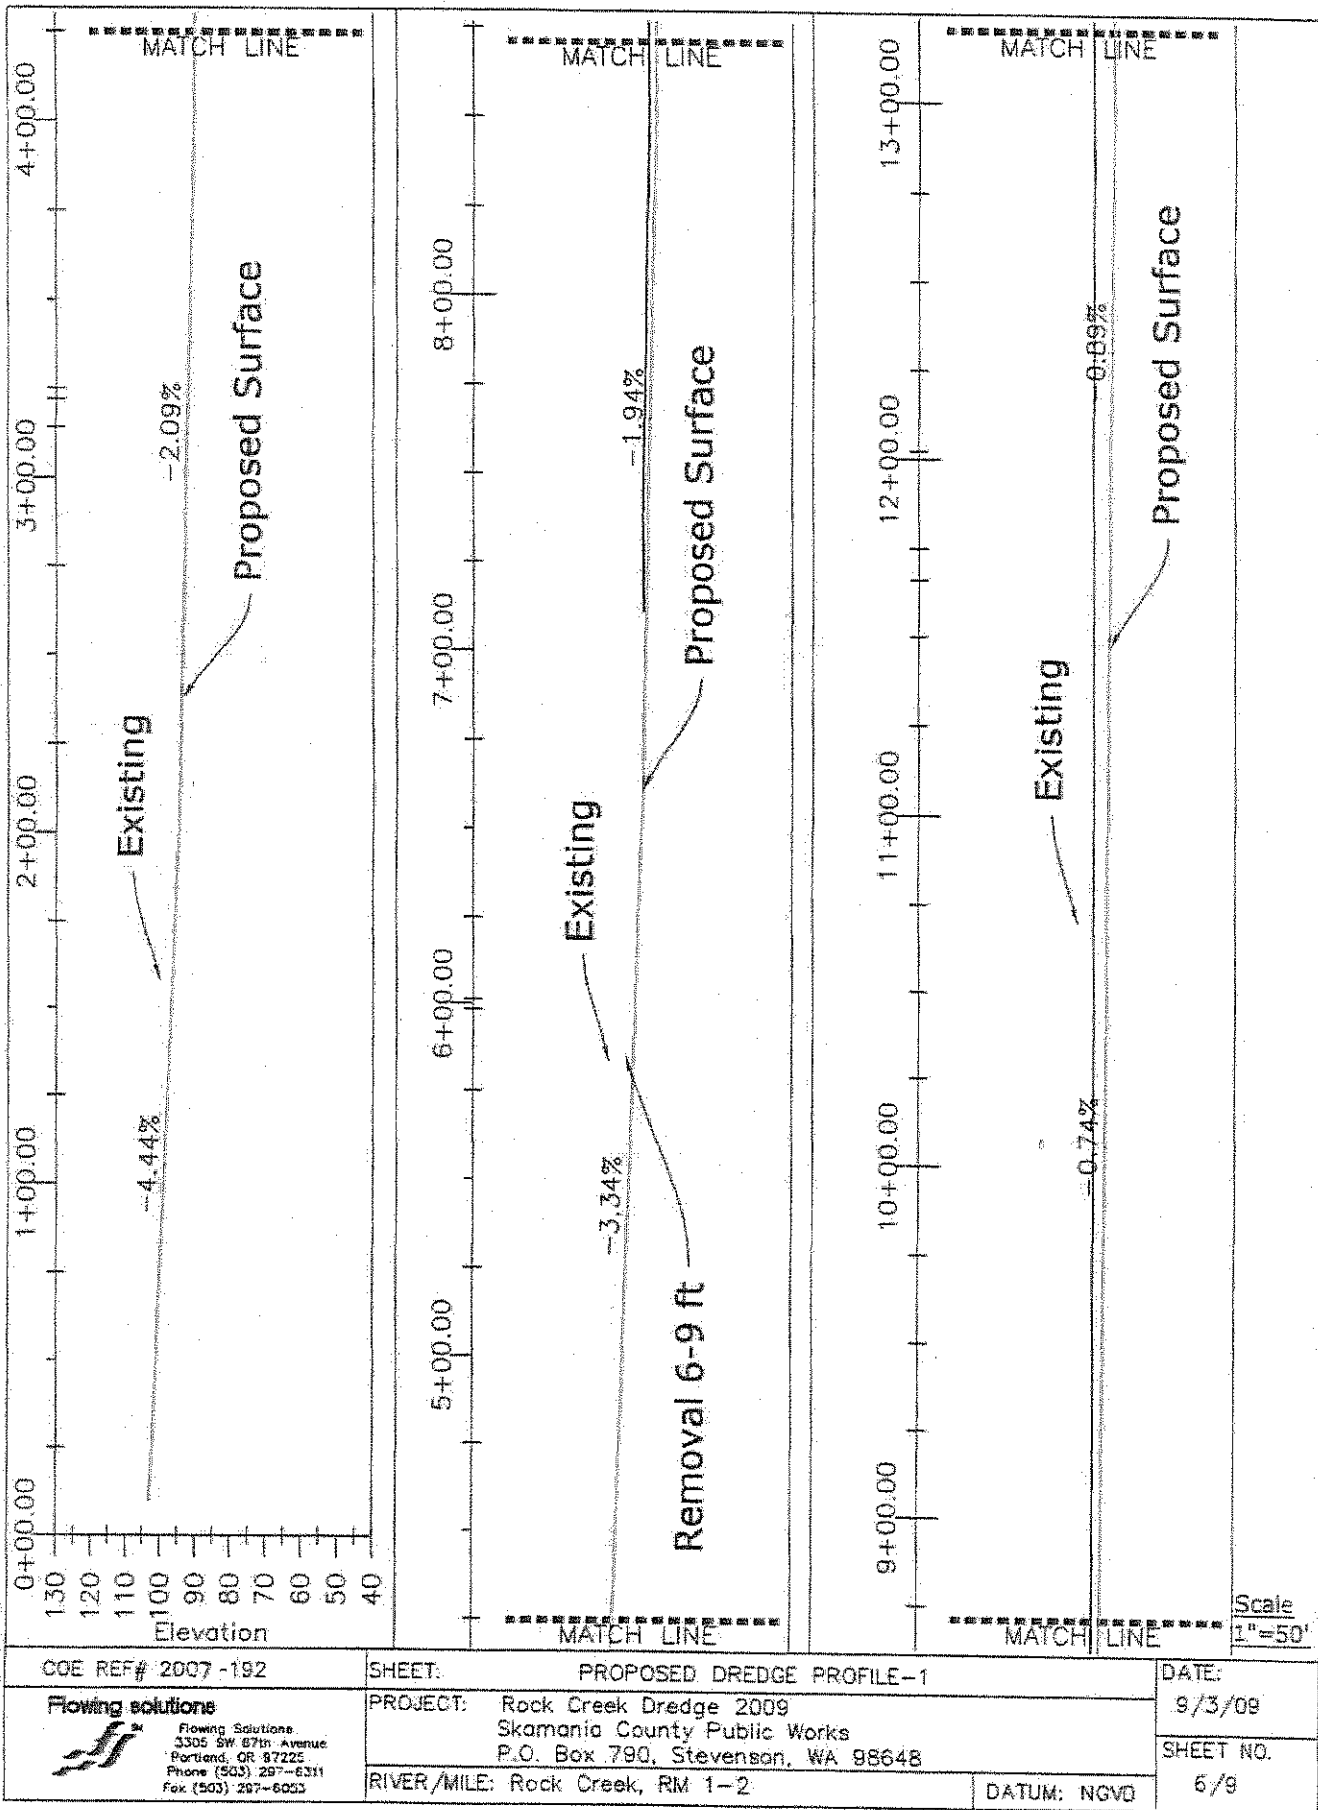

d:\fs\projects\rockcreekdredge\rockcreekdredge2009-coepermit.dwg

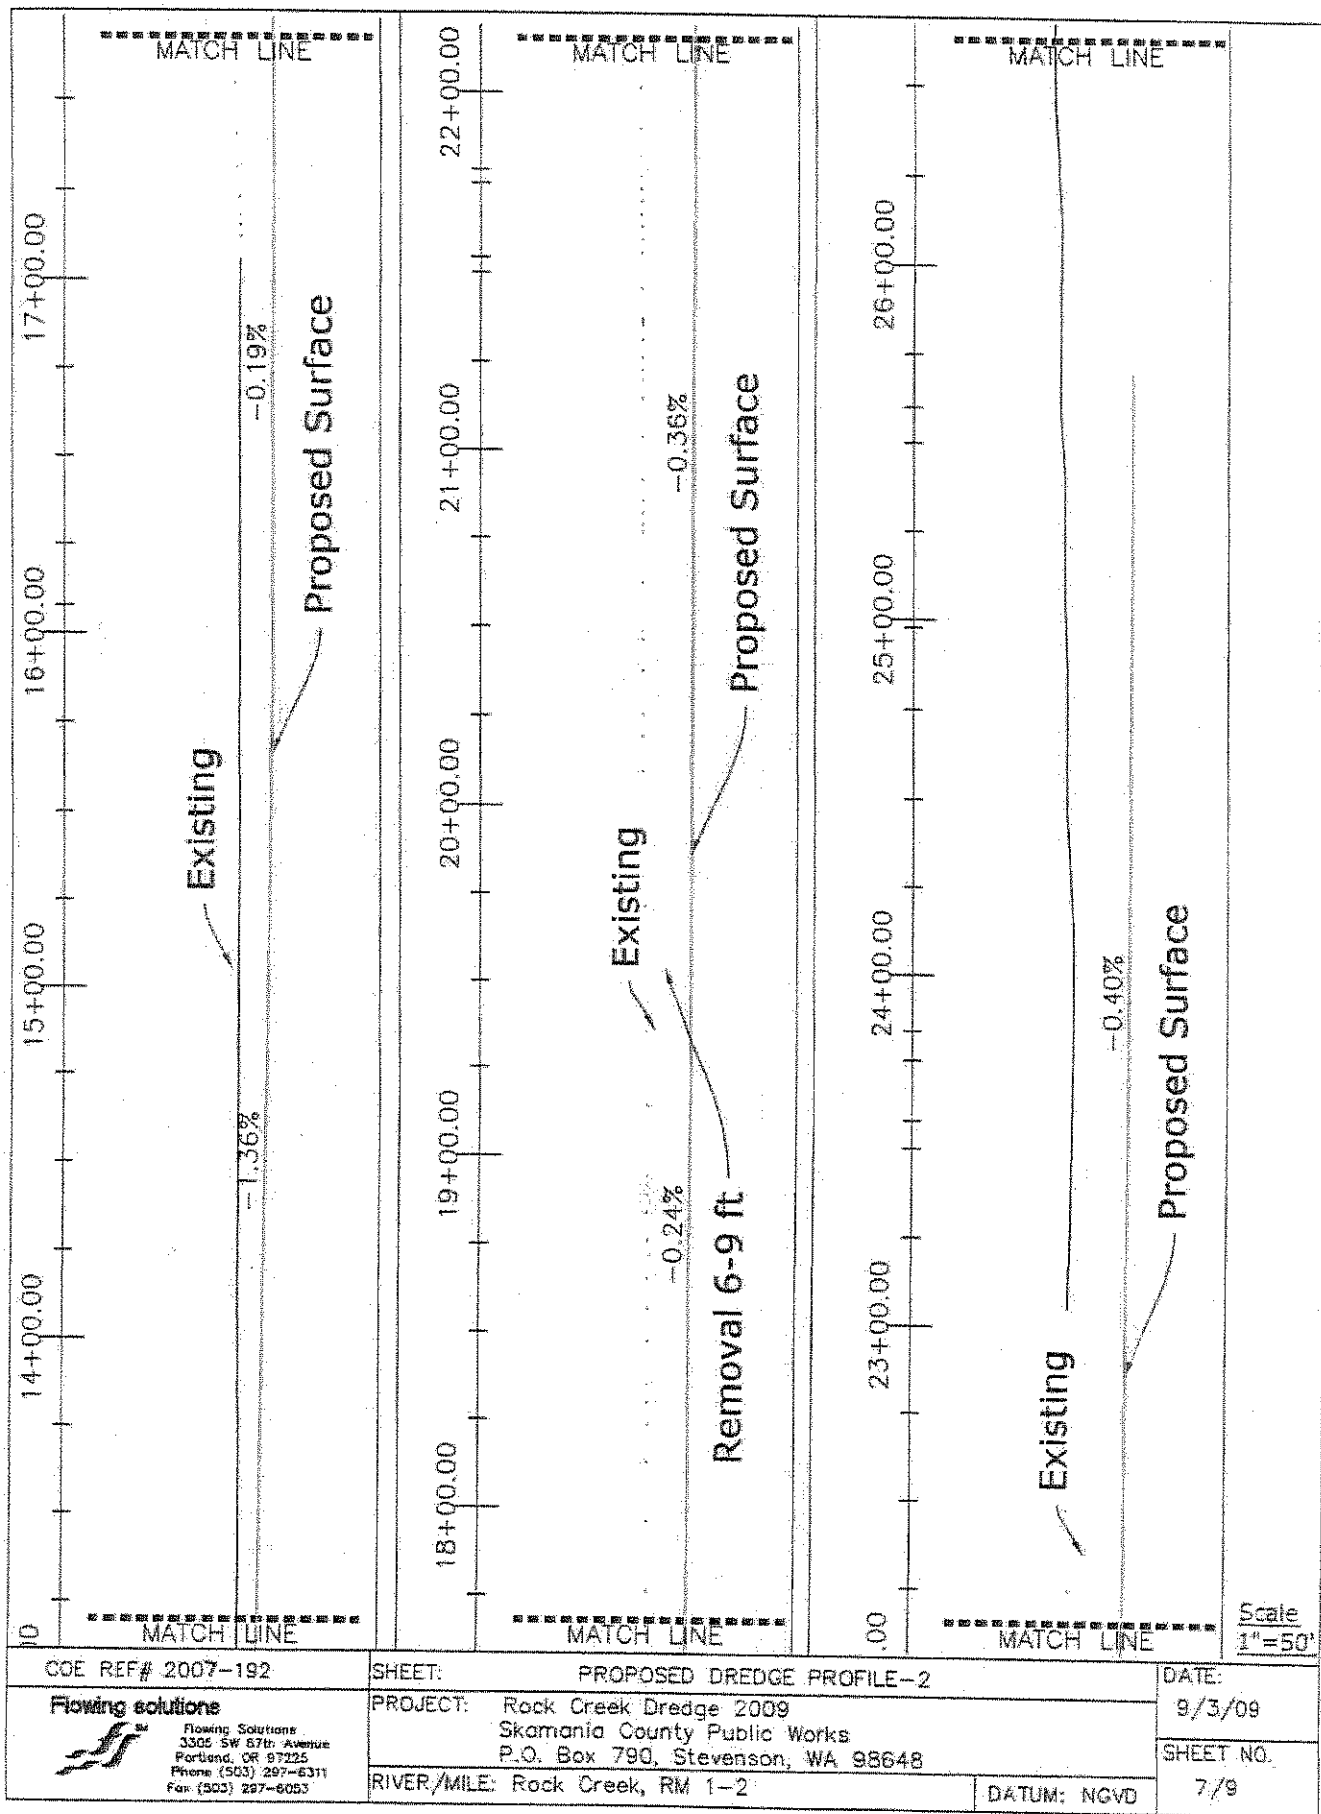

Scale
1"=50'

COE REF# 2007-192

Flowing solutions



Flowing Solutions
3305 SW 87th Avenue
Portland, OR 97225
Phone (503) 297-6311
Fax (503) 297-6053

SHEET:

PROPOSED DREDGE PROFILE-2

PROJECT:

Rock Creek Dredge 2009
Skamania County Public Works
P.O. Box 790, Stevenson, WA 98648

RIVER/MILE: Rock Creek, RM 1-2

DATUM: NGVD


DATE:

9/3/09

SHEET NO.

7/9

d:\s\projects\rockcreekdredge\rockcreekdredge2009-coepermit.dwg

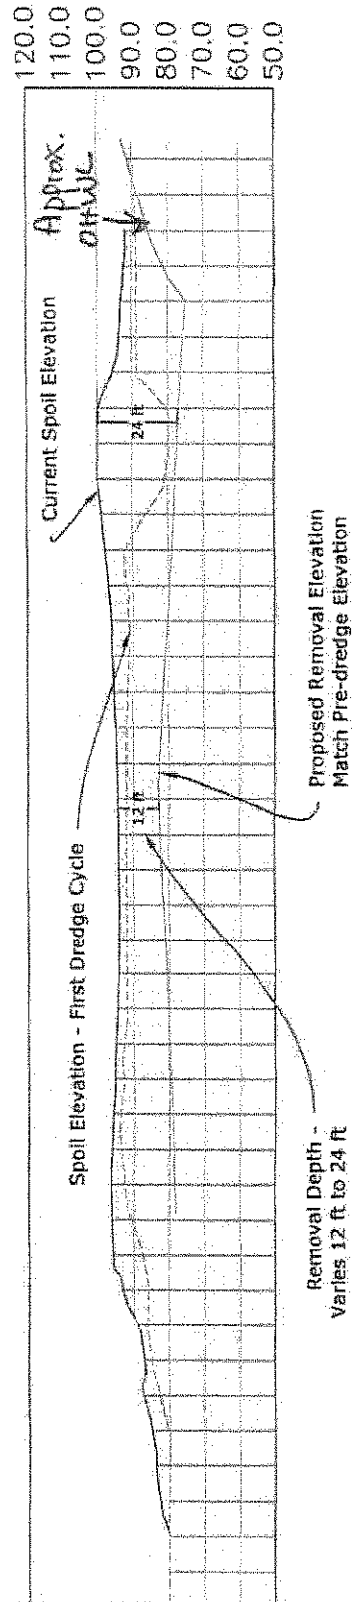

Scale
1"=50'

COE REF# 2007-192

SHEET: SPOIL REMOVAL SECTION

DATE:

Flowing solutions



Flowing Solutions
3305 SW 87th Avenue
Portland, OR 97225
Phone (503) 297-6311
Fax: (503) 297-6053

PROJECT: Rock Creek Dredge 2009
Skamania County Public Works
P.O. Box 790, Stevenson, WA 98648

RIVER/MILE: Rock Creek, RM 1-2


DATUM: NGVD

9/3/09


SHEET NO.

8/9


Section-2 - 20+53.85

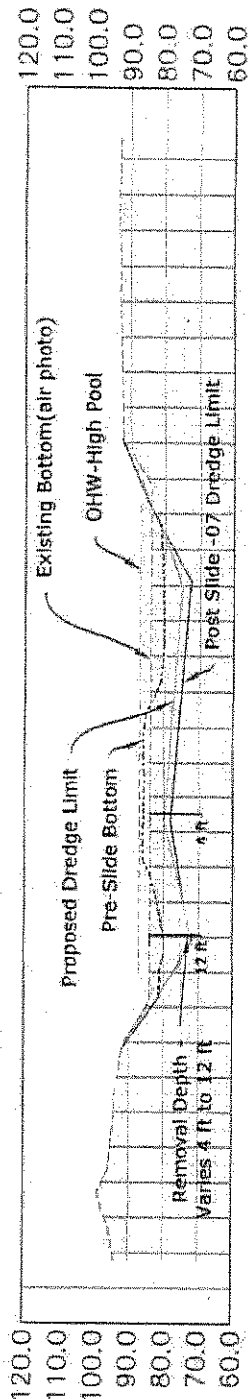

Section-3 - 23+76.34

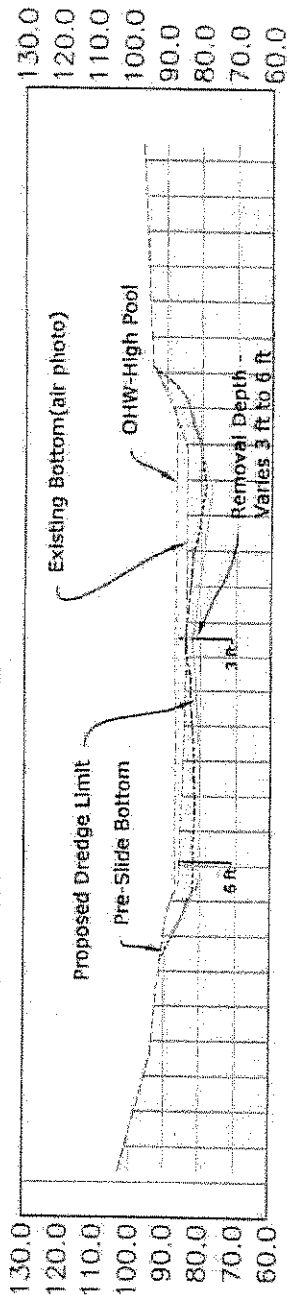

Section-4 - 26+67.84

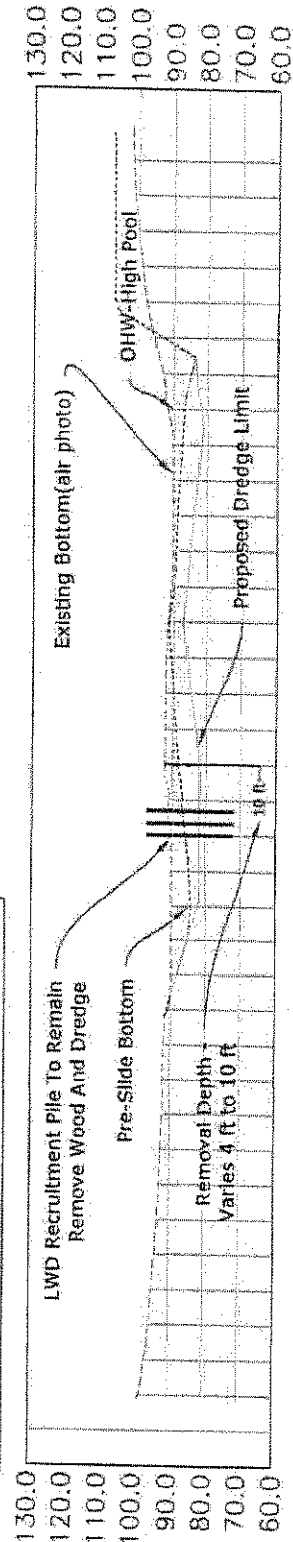

Scale
1"=50'

COE REF# 2007-192

Flowing solutions



Flowing Solutions
3305 SW 87th Avenue
Portland, OR 97225
Phone (503) 297-6311
Fax (503) 297-6053

SHEET:

PROPOSED DREDGE SECTIONS

PROJECT:

Rock Creek Dredge 2009
Skamania County Public Works
P.O. Box 790, Stevenson, WA 98648

RIVER/MILE: Rock Creek, RM 1-2

DATUM: NGVD

DATE:

9/3/09


SHEET NO.

9/9

STEVENSON SHORELINE ENHANCEMENT

PORT OF SKAMANIA

JUNE 20, 2008

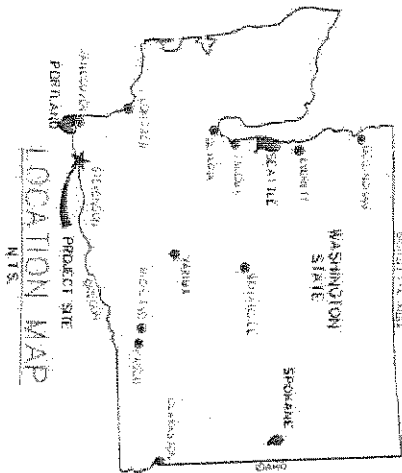

NE 1/4 Section 1, Township 02 North, Range 07 East, W.M.
Latitude: 45.69229
Longitude: -121.89037
Skamania County

GENERAL NOTES

1. ALL WORK IS TO CONFORM WITH PROJECT CONTRACT SPECIFICATIONS.
2. THE COMPLETED INSTALLATION SHALL CONFORM TO ALL APPLICABLE FEDERAL, STATE, AND LOCAL CODES, ORDINANCES, AND REGULATIONS INCLUDING NECESSARY PERMITS AND INSPECTIONS REQUIRED BY THE GOVERNING AUTHORITIES. THE TERMS OF THE STATE OF WASHINGTON HYDRAULIC PROJECT APPROVAL (HPA) AND THE CORP OF ENGINEERS PERMIT SHALL BE OBSERVED. ALL IN WATER WORK SHALL BE COMPLETED WITHIN GUIDELINES ESTABLISHED IN THE PERMIT DOCUMENTS.
3. THE CONTRACTOR SHALL BE RESPONSIBLE FOR COORDINATING ALL SCHEDULING AND ALL WORK WITH THE OWNER.
4. THE ENGINEER OR OWNER IS NOT RESPONSIBLE FOR THE SAFETY OF THE CONTRACTOR OR HIS CREW. ALL O.S.H.A. REGULATIONS SHALL BE STRICTLY ADHERED TO IN THE PERFORMANCE OF THE WORK.
5. THE CONTRACTOR IS RESPONSIBLE FOR MAINTAINING ALL ROADWAYS, KEEPING THEM CLEAN AND FREE OF CONSTRUCTION MATERIALS AND DEBRIS, AND PROVIDING NECESSARY DUST CONTROL WHERE REQUIRED.
6. WATER LEVELS ARE FOR REFERENCE ONLY. WATER LEVELS AT THE TIME OF CONSTRUCTION ARE NOT GUARANTEED. CONSTRUCTION MEANS, METHODS, AND MATERIALS TO FACILITATE COMPLETION OF PROJECT ARE THE RESPONSIBILITY OF THE CONTRACTOR.

PROJECT DESCRIPTION

PLACE OWNER PROVIDED ROUND RIVER ROCK/GRAVEL ALONG SHORELINE TO COVER EXISTING RIP-RAP, EXISTING SHEET PILE WALL, AND ERODING BANK, INSTALL ROOT-WAD HABITAT ELEMENTS, AND RIPARIAN PLANTINGS.

OWNER

PORT OF SKAMANIA COUNTY
PO BOX 1099
70 SE CASCADE AVENUE
STEVENSON, WASHINGTON 98648
PHONE: (509) 427-5484
FAX: (509) 427-7964

ENGINEER


FLOWING SOLUTIONS
3305 SW 87TH
PORTLAND, OR 97225
PHONE: (503) 297-6311
FAX: (503) 297-6053

SHEET INDEX

1. COVER
2. SITE
3. PLAN WEST
4. PLAN EAST
5. PLANNING
6. BANK DETAIL
7. EROSION CONTROL PLAN
8. SECTIONS 4.5
9. SECTIONS 6.7
10. SECTIONS 8.9
11. SECTIONS 10.11
12. SECTIONS 12.13
13. SECTIONS 14.15

Corps Ref. # 2007-192 Skamania County


FLOWING SOLUTIONS		COVER		SHEET	
				1	14
				Stevenson Shoreline Enhancement, Port of Skamania PO Box 1099 Stevenson, Washington 98648 DATE: June 20, 2008 PROJECT: Stevenson	

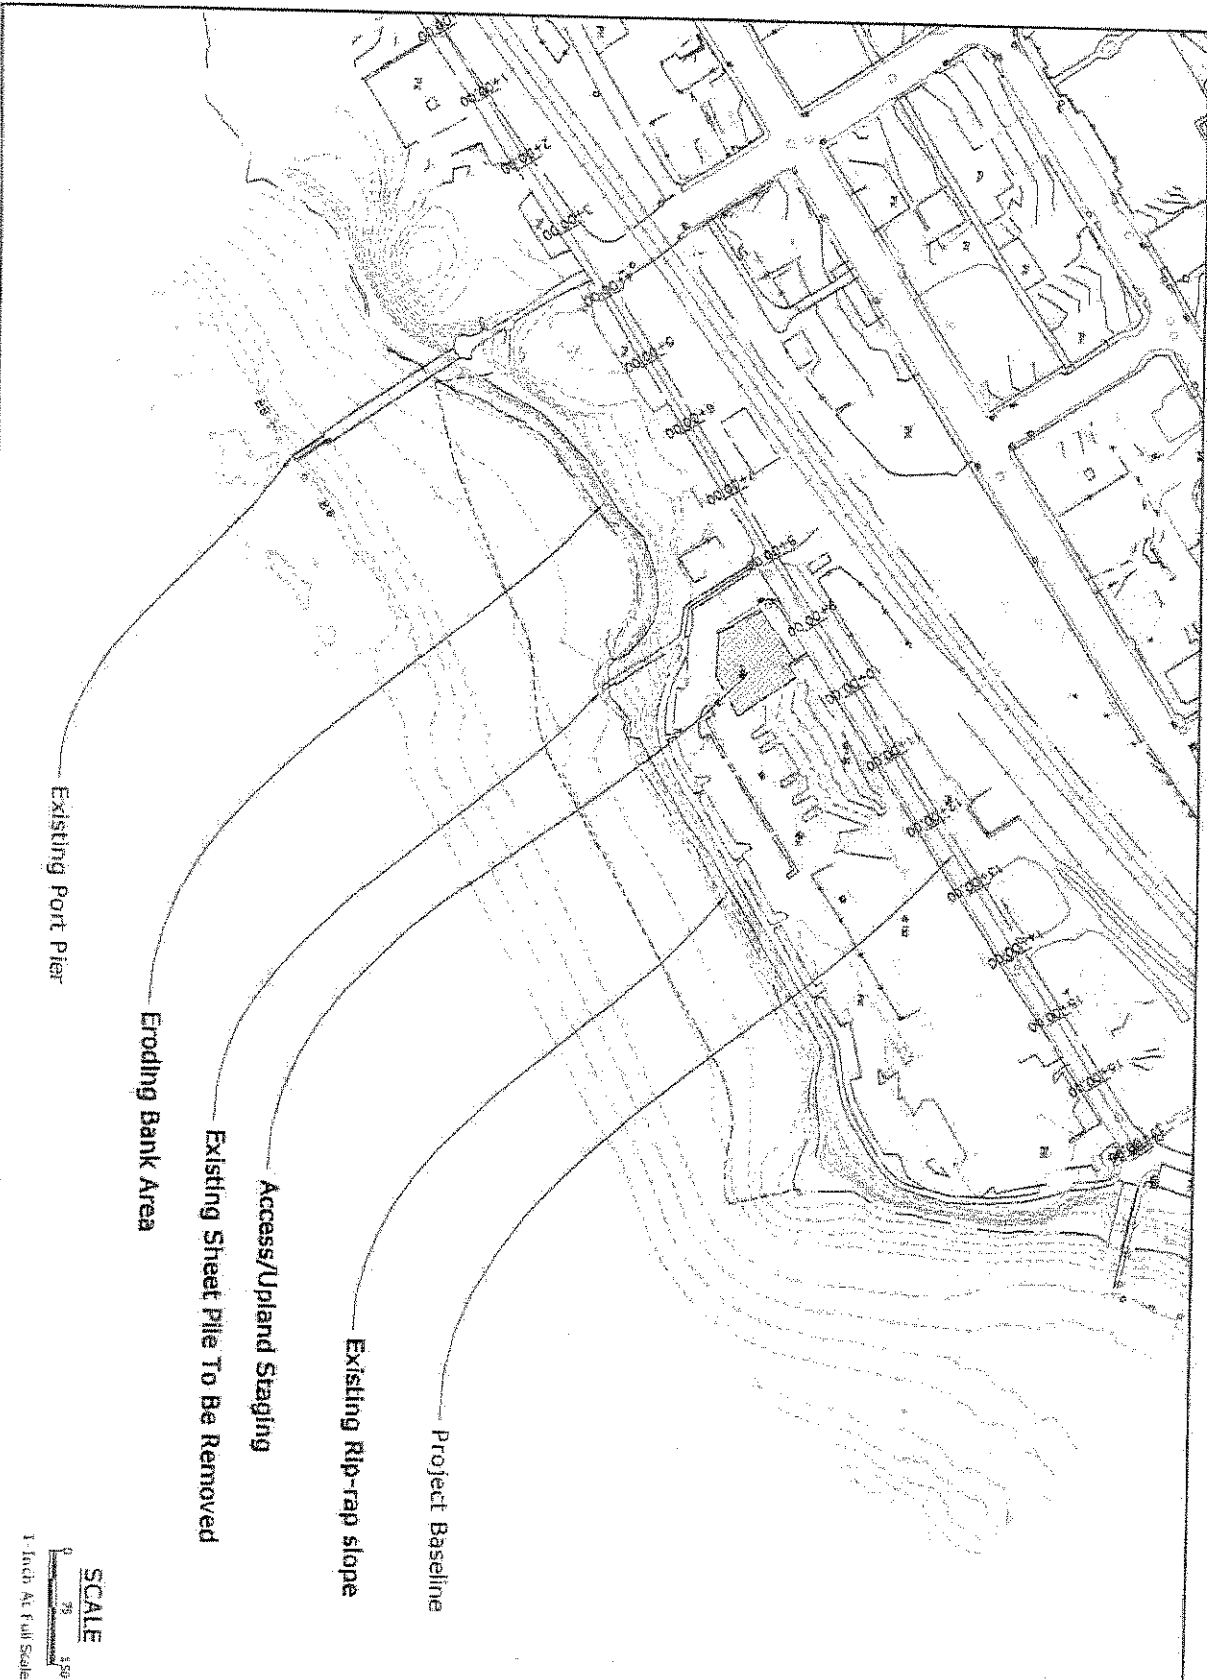

SCALE
0 75 150
1-Inch At Full Scale


Corps Ref. # 2007-k2 Skamania County

NO.	DATE	REVISION	BY	APPVED	SCALE	Flowing solutions	SITE	SHEET
1						Flowing solutions	Skamania County	2
2						Flowing solutions	Skamania County	14
3						Flowing solutions	Skamania County	
4						Flowing solutions	Skamania County	
5						Flowing solutions	Skamania County	
6						Flowing solutions	Skamania County	
7						Flowing solutions	Skamania County	
8						Flowing solutions	Skamania County	
9						Flowing solutions	Skamania County	
10						Flowing solutions	Skamania County	
11						Flowing solutions	Skamania County	
12						Flowing solutions	Skamania County	
13						Flowing solutions	Skamania County	
14						Flowing solutions	Skamania County	
15						Flowing solutions	Skamania County	
16						Flowing solutions	Skamania County	
17						Flowing solutions	Skamania County	
18						Flowing solutions	Skamania County	
19						Flowing solutions	Skamania County	
20						Flowing solutions	Skamania County	

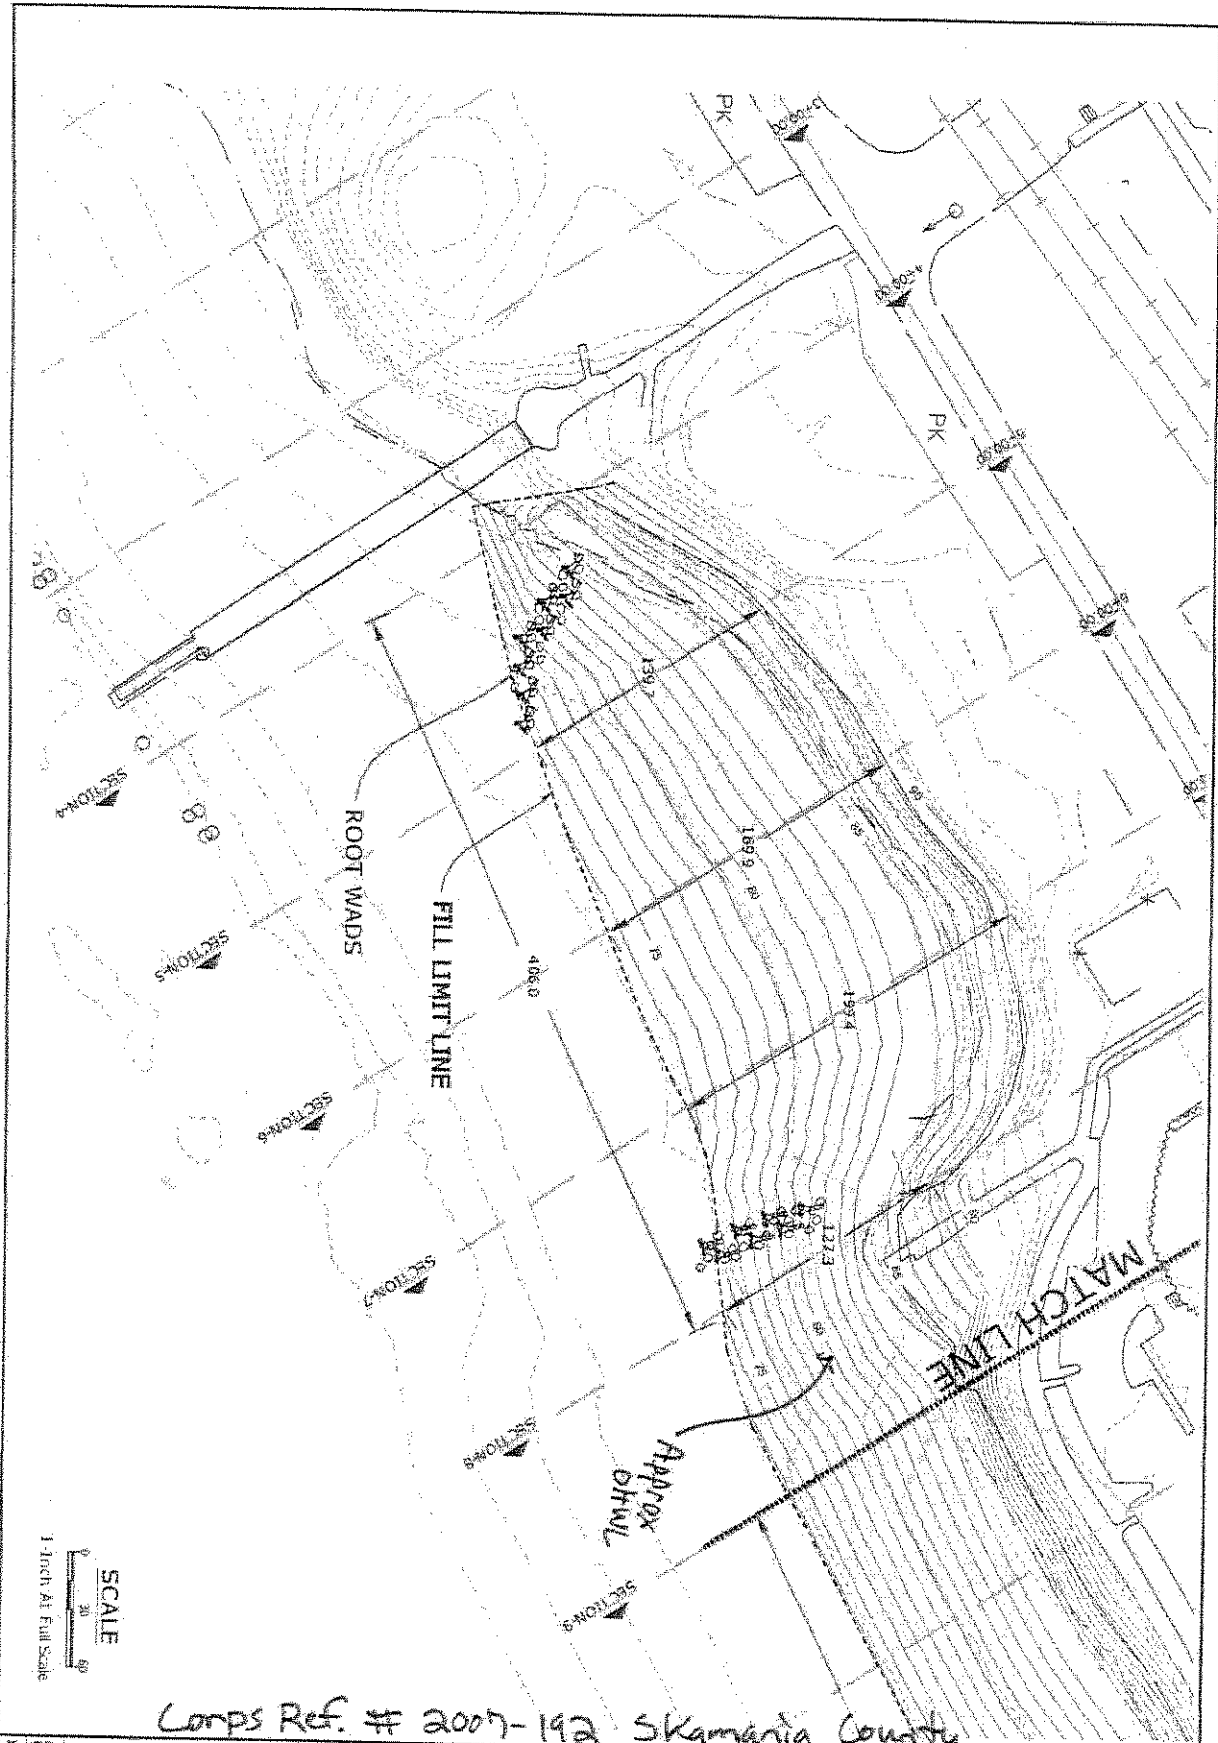


Corps Ref. # 2007-192 Skamania County


NO.	DATE	REVISION	BY	APP'D	SEAL	FLUOR SOLUTIONS	PLAN-WEST	SHEET
1						FLUOR SOLUTIONS	PLAN-WEST	4
2						FLUOR SOLUTIONS	PLAN-WEST	14
3						FLUOR SOLUTIONS	PLAN-WEST	
4						FLUOR SOLUTIONS	PLAN-WEST	
5						FLUOR SOLUTIONS	PLAN-WEST	
100						FLUOR SOLUTIONS	PLAN-WEST	

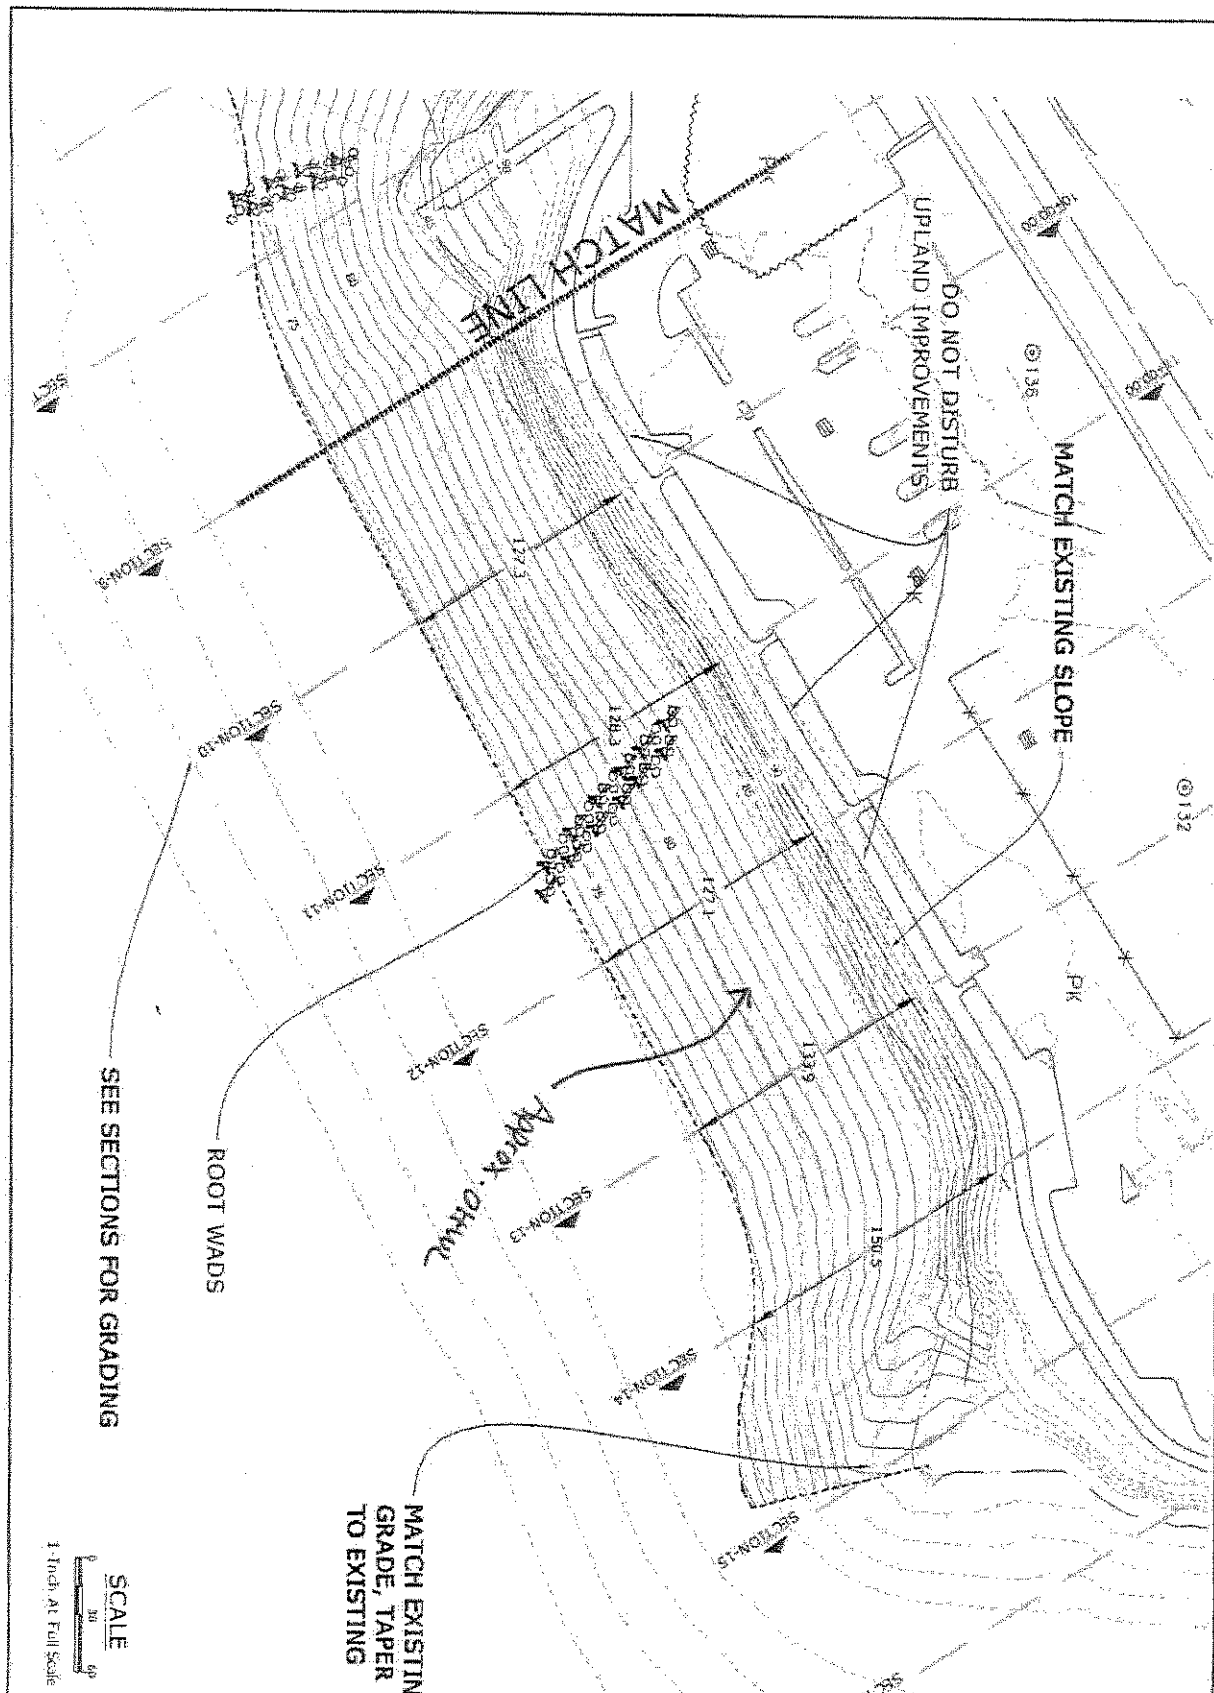

Corps Ref. # 2009-192 Skamania County


SHEET 14	DRAWING 14	DATE 10/1/2009	PROJECT 14	PLAN EAST Stevenson Elementary School, Port of Skamania 1000 Hwy 100 Stevenson, Washington 98648 DATE: 10/1/2009 PROJECT: 14
-------------	---------------	-------------------	---------------	--

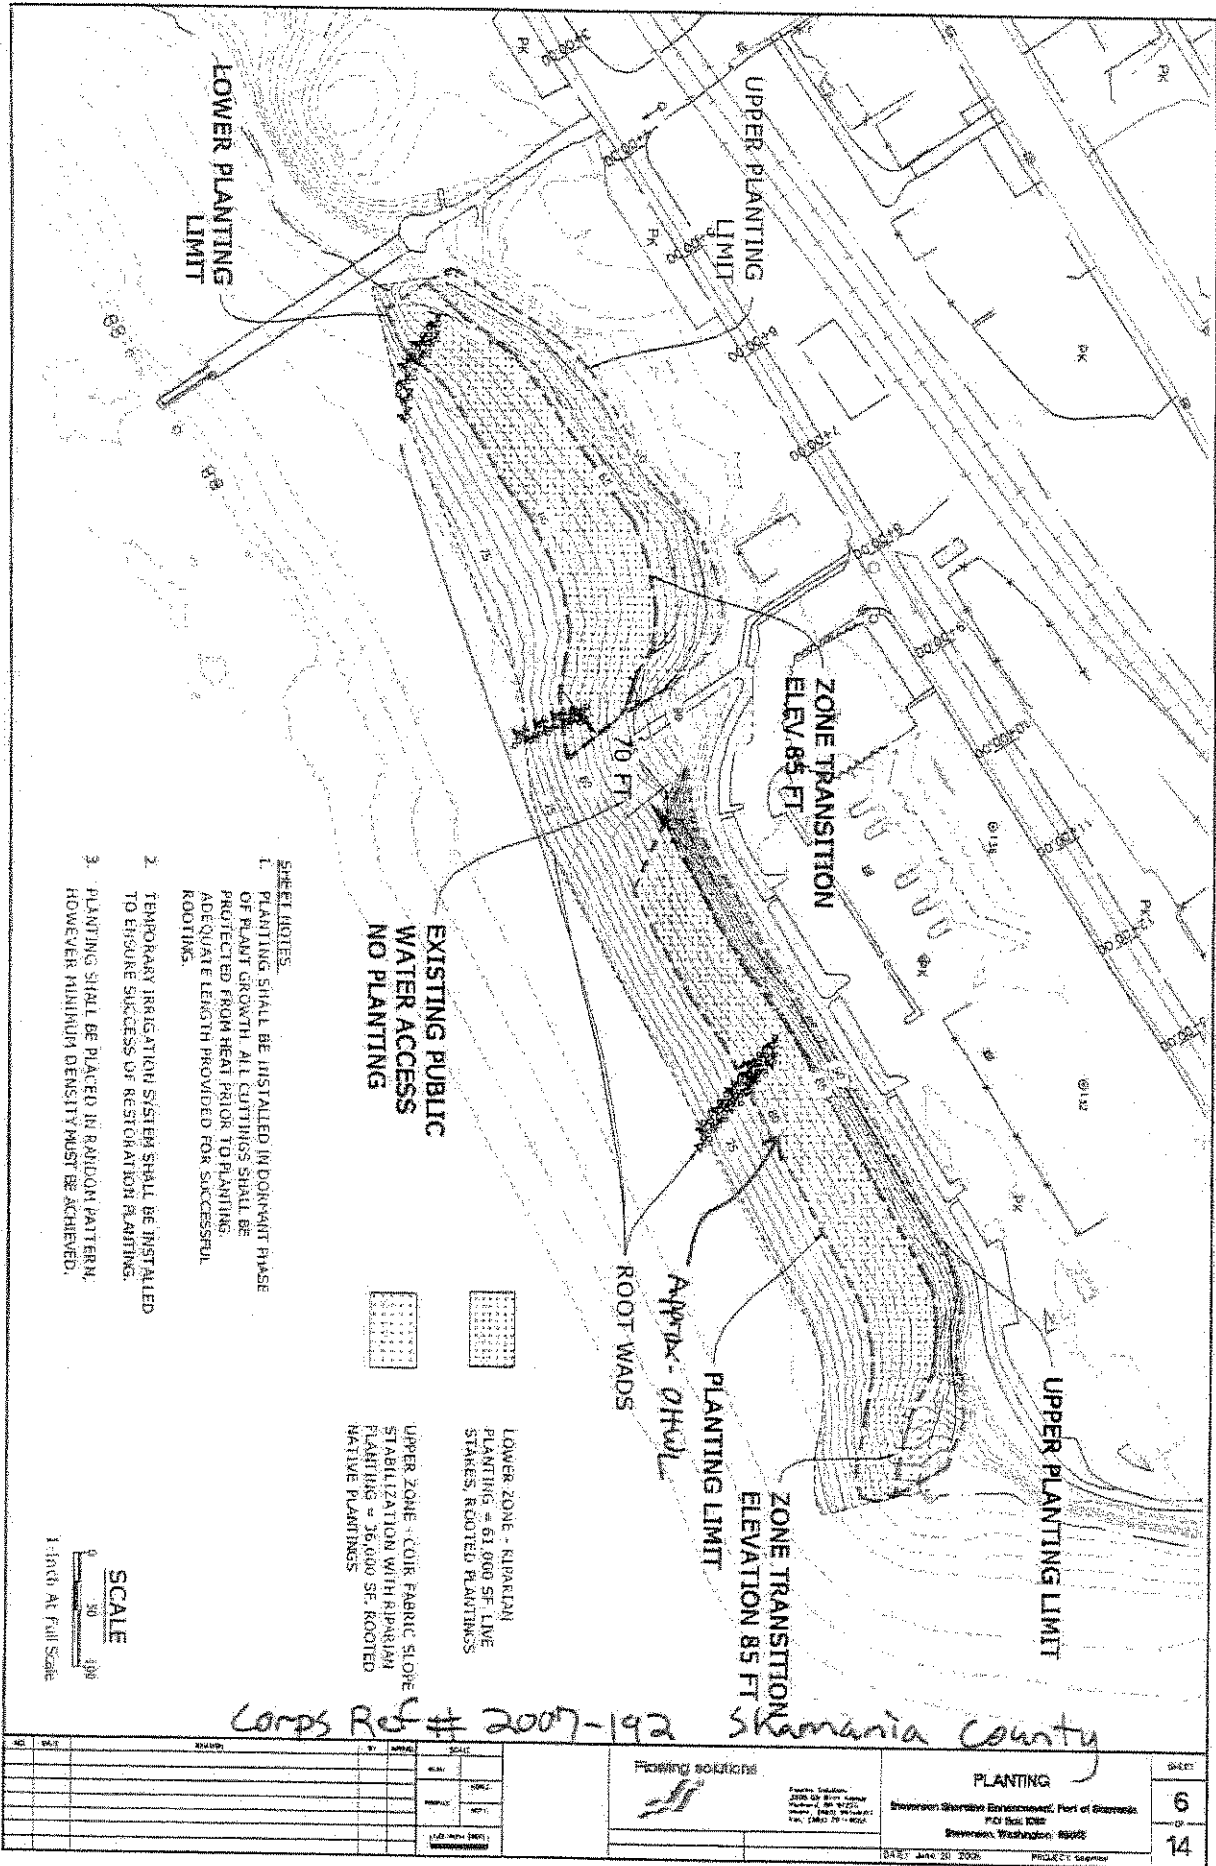

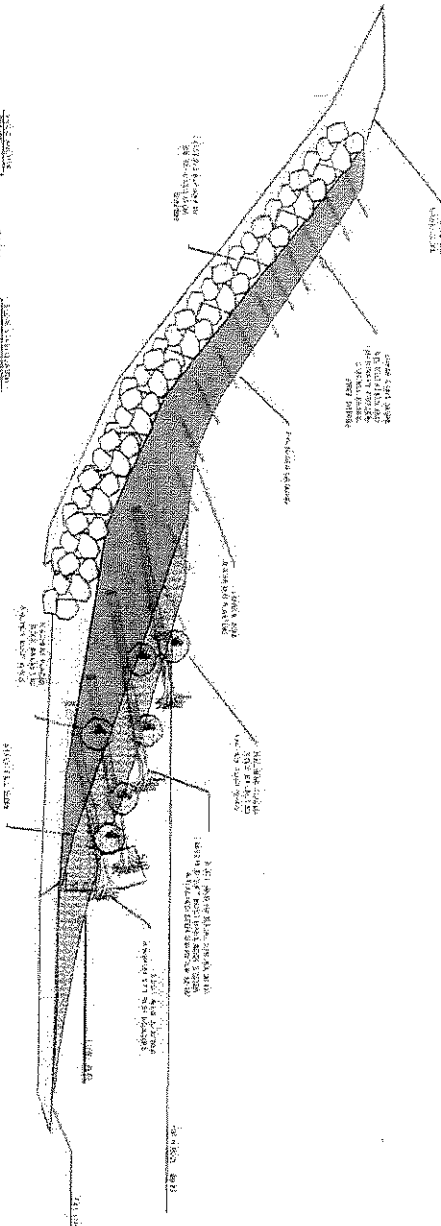


APPROX. DETAIL

BANK AND ROOT WALL DETAIL

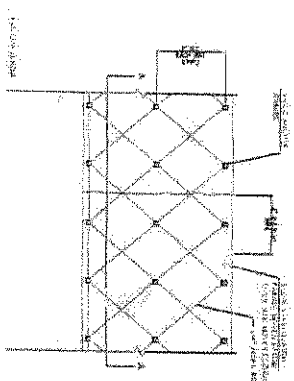


PLAN

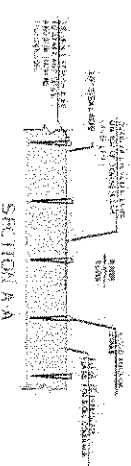

SECTION A-A

SLOPE STABILIZATION FABRIC
PLAN AND SECTION

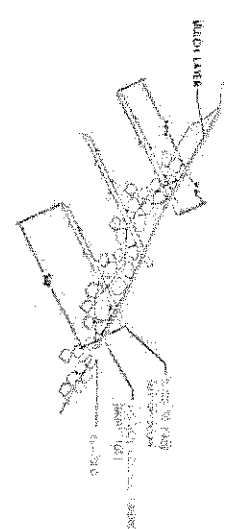


WALL LAYER

NOTE: PLANT STAKES ON 4' DBD

VEGETATION	DATE	BY	COMMENTS
PLANT STAKES	10/1/00	WJ	10' DBD
PLANT STAKES	10/1/00	WJ	10' DBD
REVEGETATION DETAIL

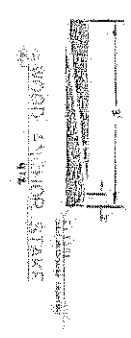

WOOD STAKE
1/2\"/>

Corps Ref. # 2007-192 Skamania County

Flowing solutions 		BANK DETAIL Erosion Control Enhancement, Part of Skamania P.O. Box 630 Bremerton, Washington 98340		SHEET 7 OF 14
PROJECT NO. 2007-192 PROJECT NAME		DATE: 10/1/00		PROJECT LOCATION

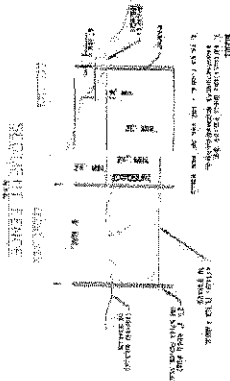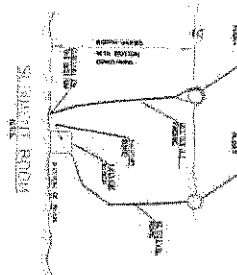

STUDENT CODE

1. The following information was obtained from a review of the files of the Federal Bureau of Investigation, Department of Justice, and the Central Intelligence Agency, Office of the Director of Central Intelligence, regarding the activities of the following individuals:

2. [REDACTED]

3. [REDACTED]

4. [REDACTED]

297. [REDACTED]

298. [RE

2019

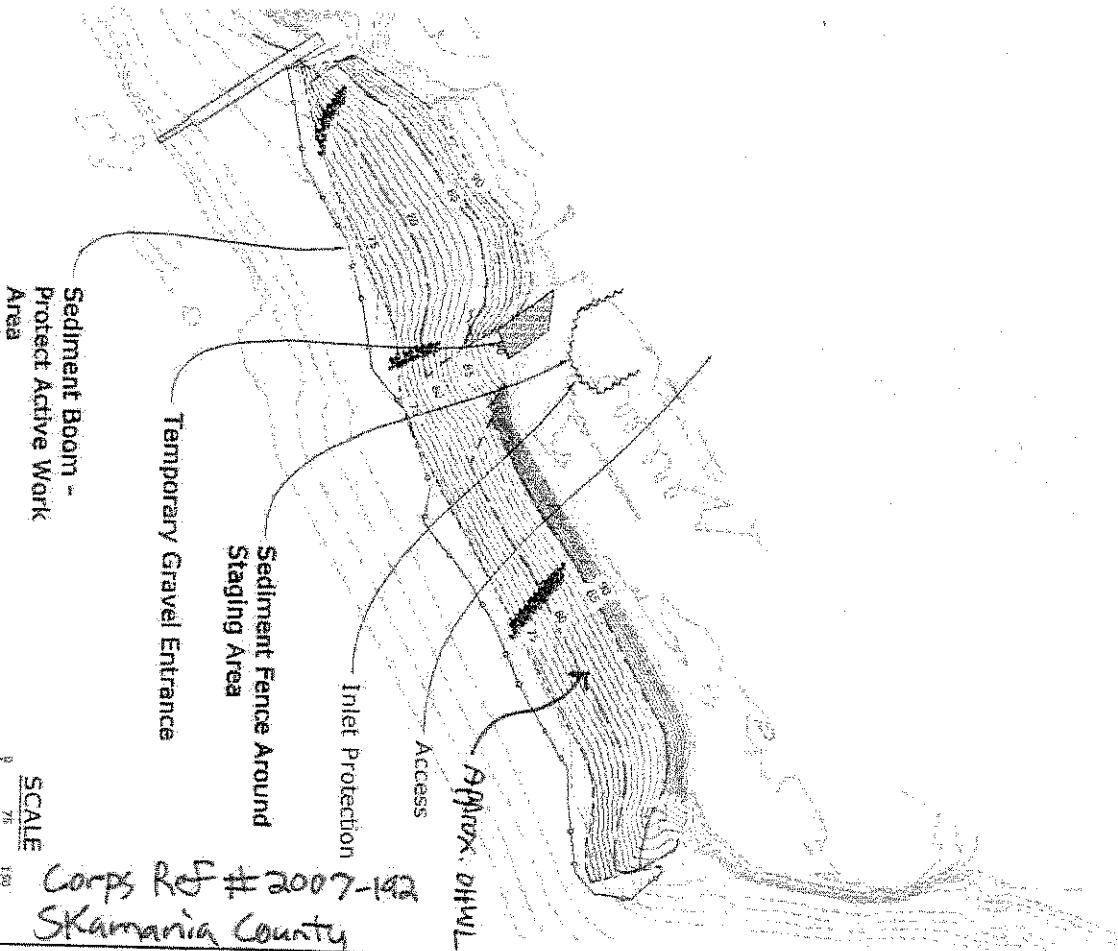[illegible]


SCALE

0 7 1/2 1 1/2

1-Inch At Full Scale



Corps Ref # 2007-192
Skamania County

REV.	DATE	REVISION	BY	APPROVED	DATE	<p>Flowing solutions</p>  <p>Flowing Solutions 2000 1st Ave. S.W. Burien, WA 98148 Phone: 206-835-1000 Fax: 206-835-1001</p>	<p>EROSION CONTROL PLAN</p> <p>Stewart Street Environment, Part of Stewart Rd. Exit 1008 Burien, Washington 98148</p>	<p>DATE: June 20, 2006</p> <p>PROJECT: Stewart</p>	<p>SHEET</p> <p>8</p> <p>OF</p> <p>14</p>

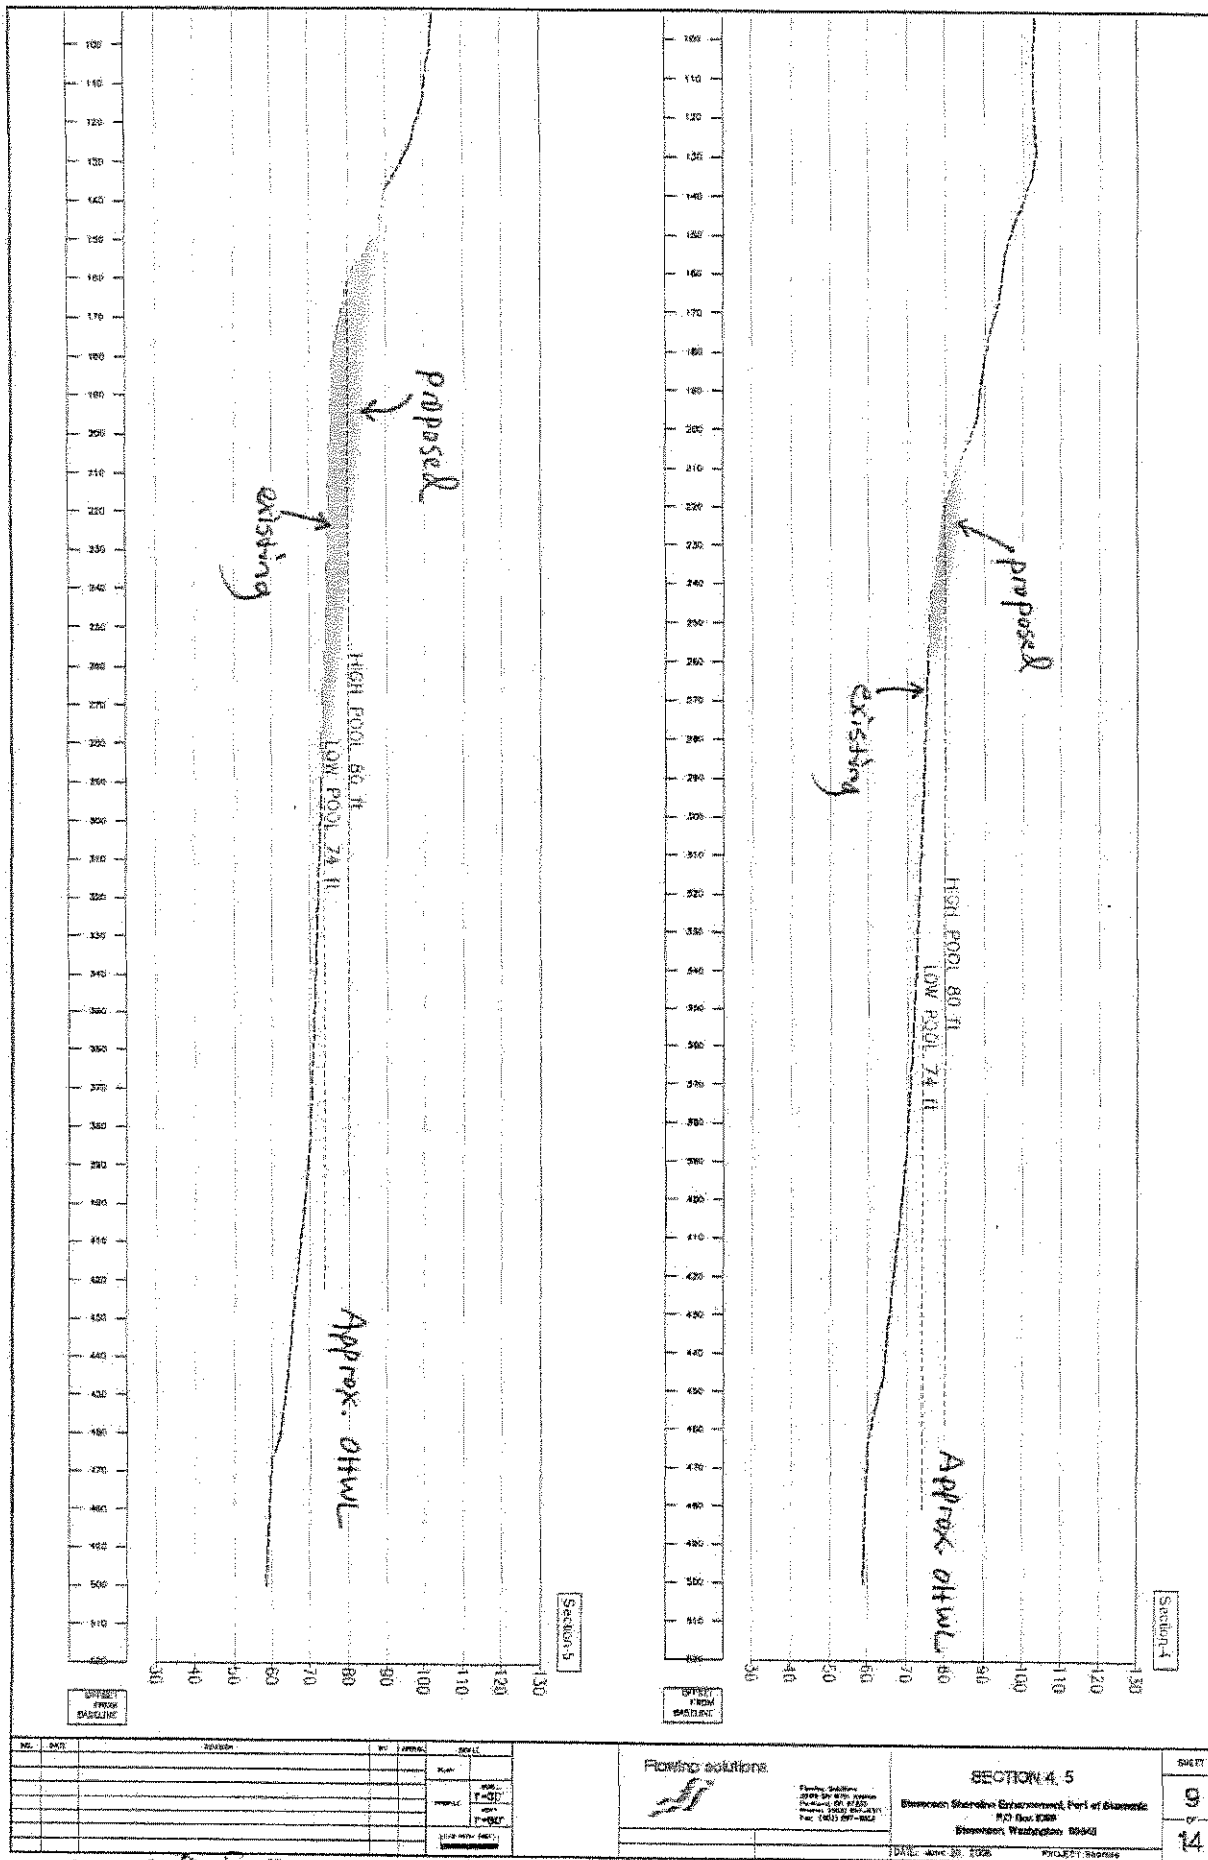


No. DATE 1 2 3 1469 14	
---	--

Existing Sheet Pile Wall to Be Removed

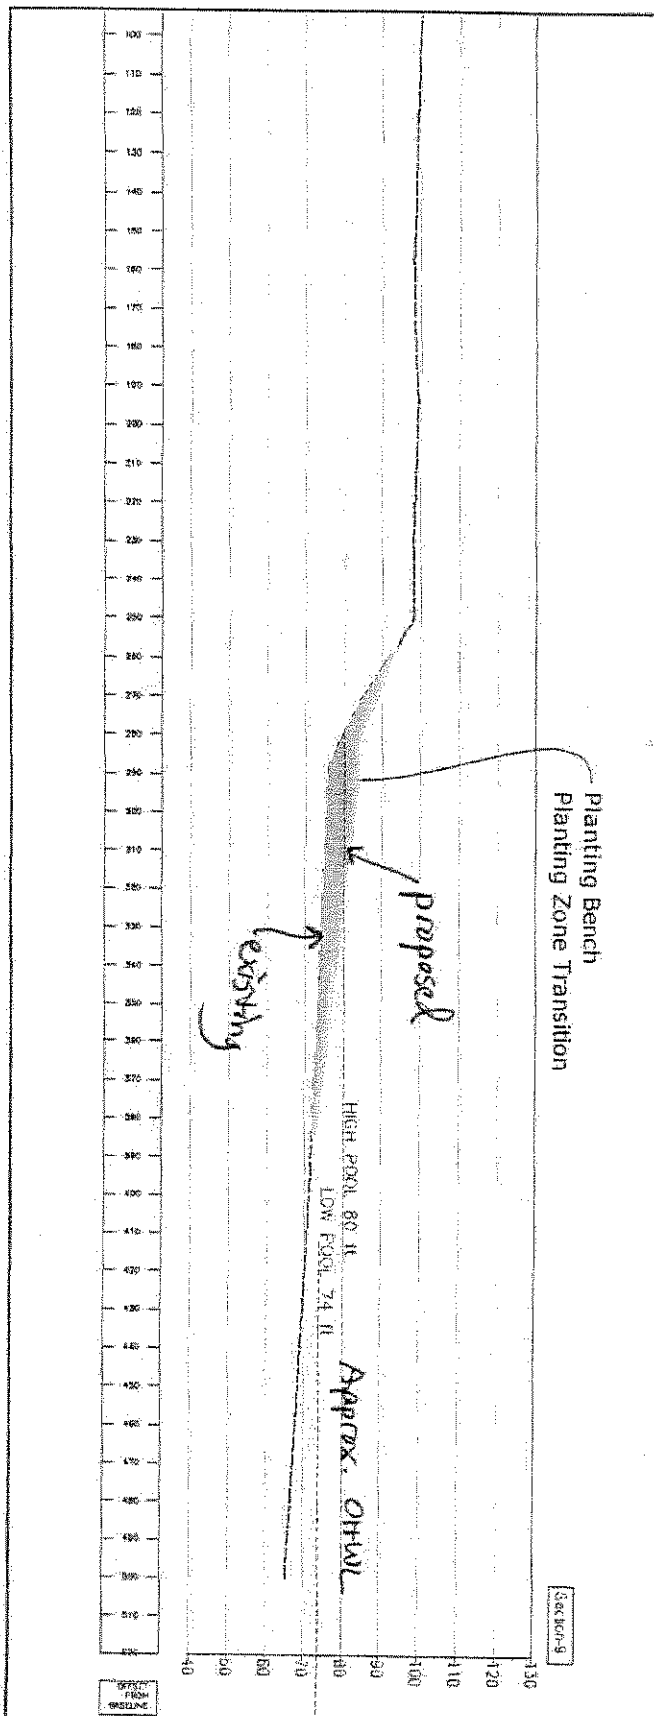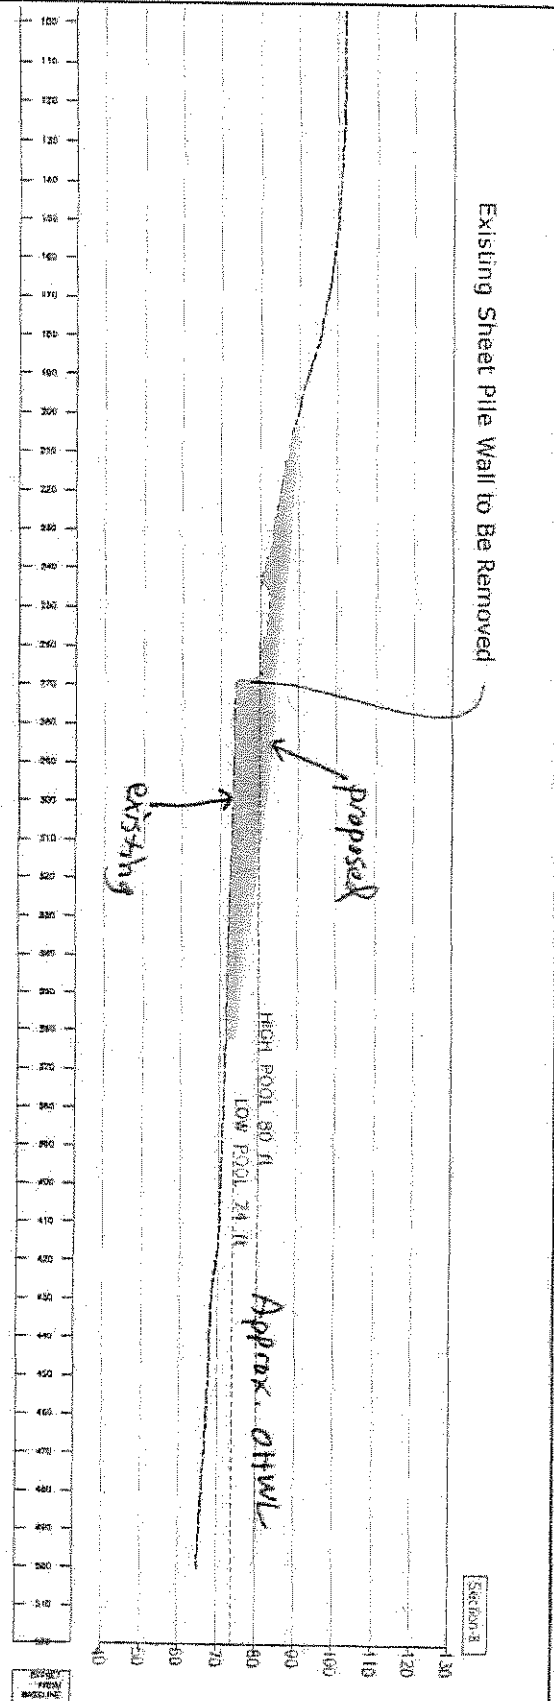


NO. DATE		REVISION		BY		DATE		FLOWING SOLUTIONS		SECTION 5, 9		WILEY	
												11	
												14	

Corps Ref. # 2007-192 Skamania County

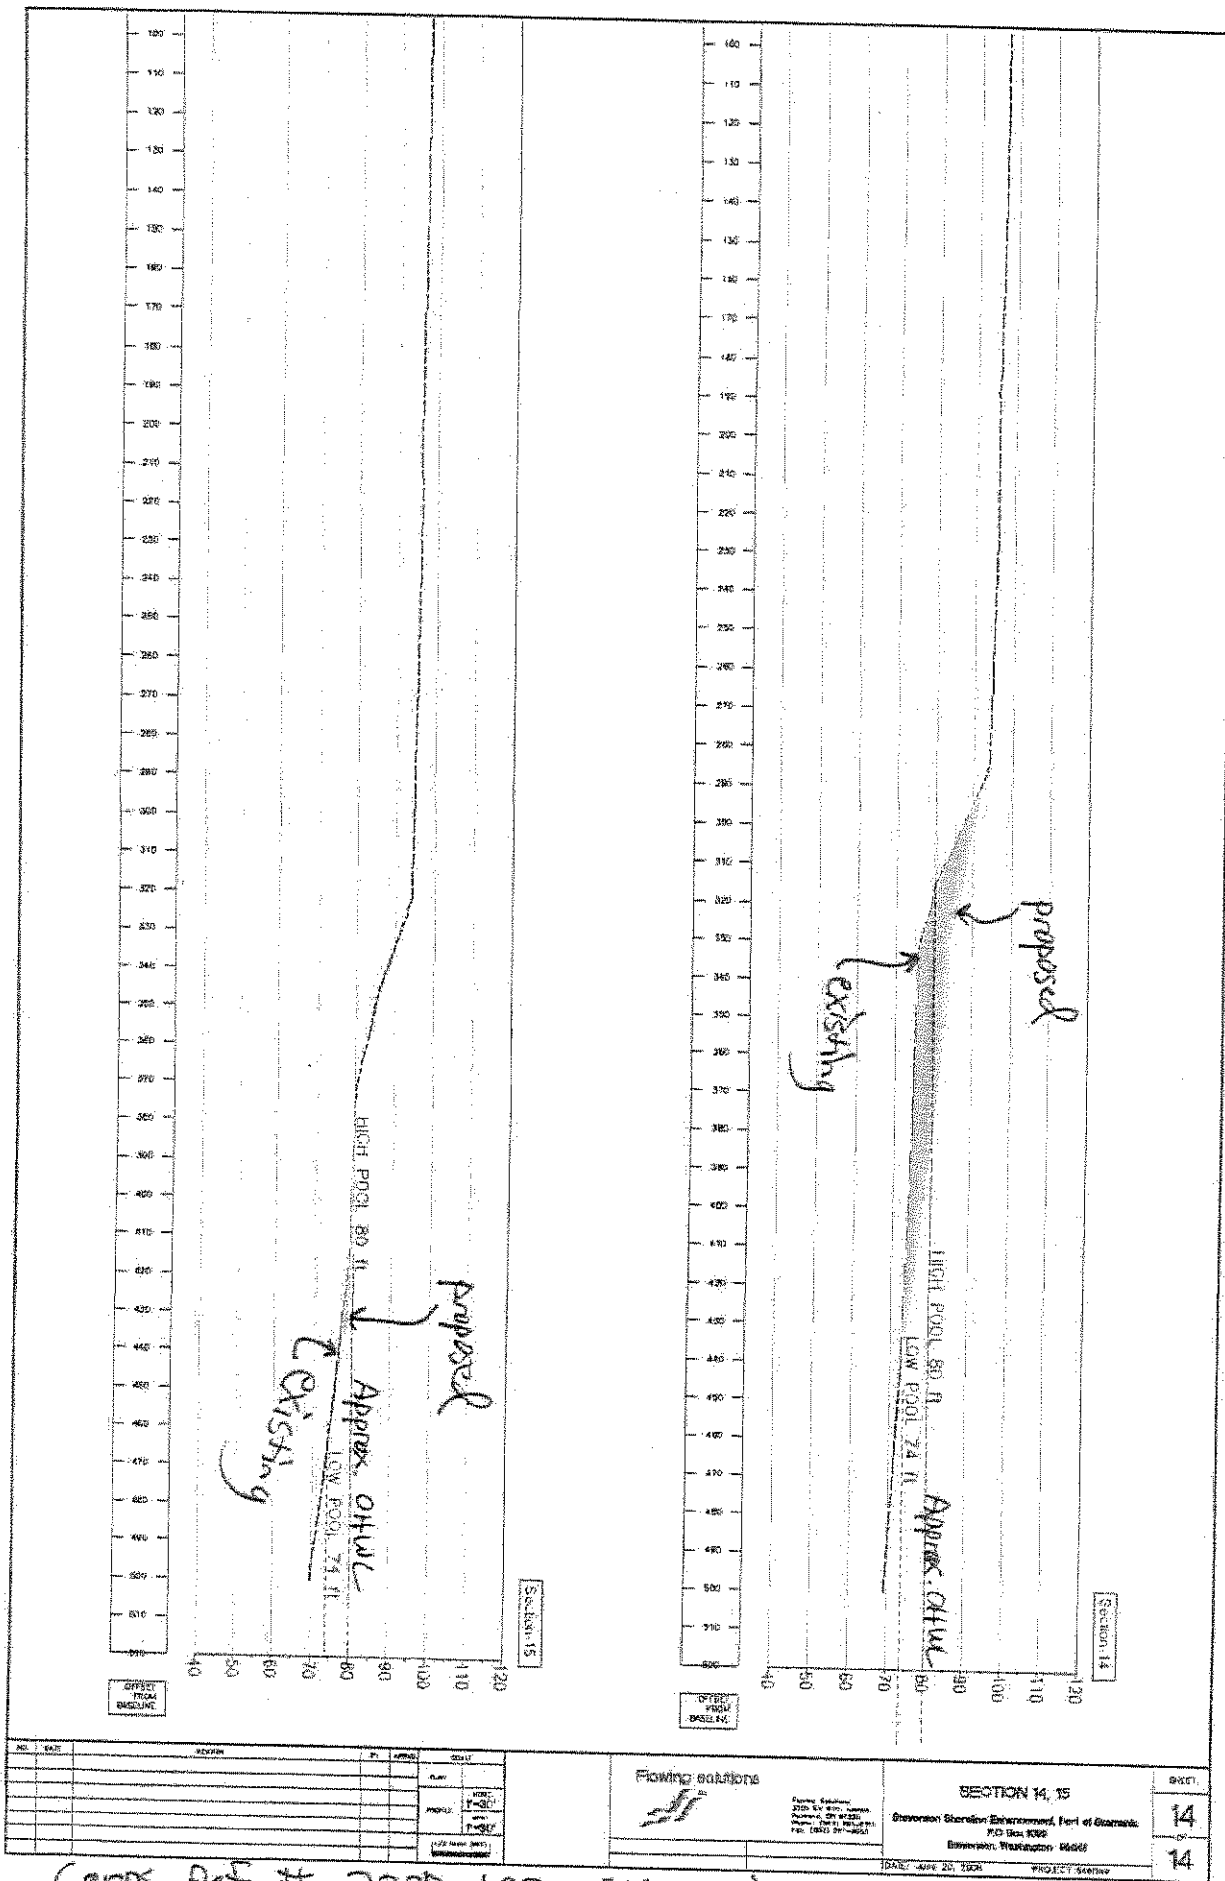

Corps. Ref. # 2007-192-5Kamahi County

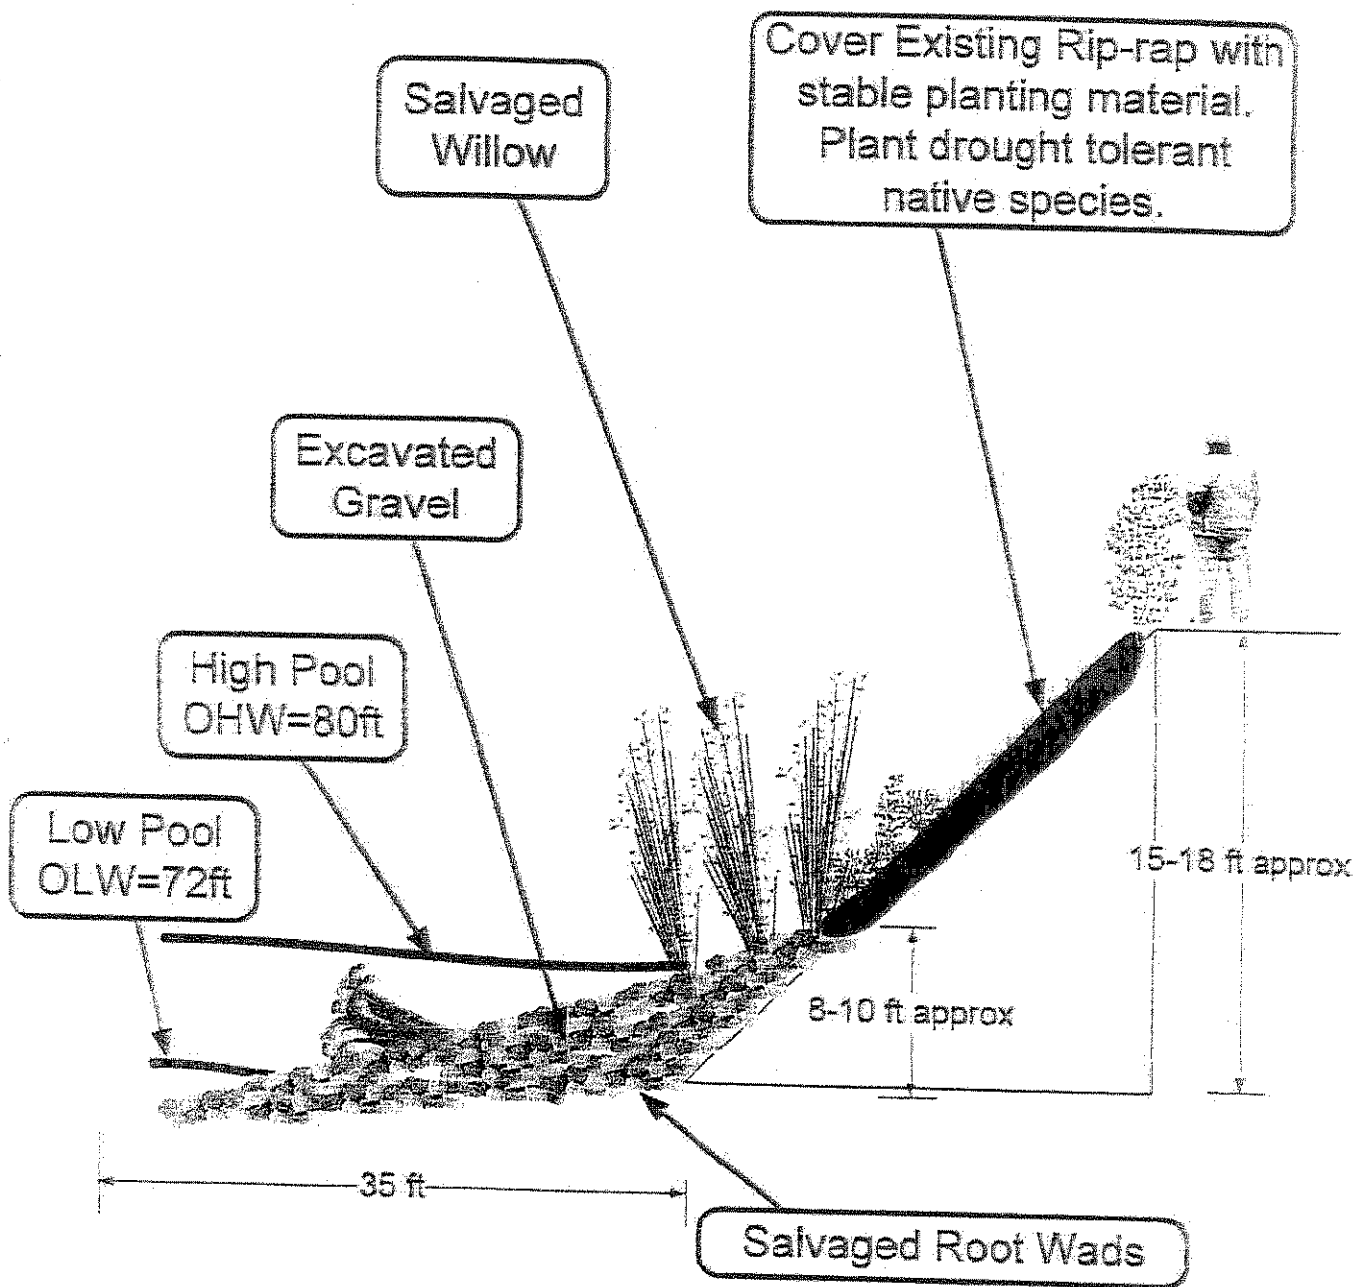

REF: NWS-2007-192-CRS

Skamania County Public Works


In: Rock Creek

At: Stevenson, WA

12 April 2007



Proposed Mitigation

Typical 1 of 2

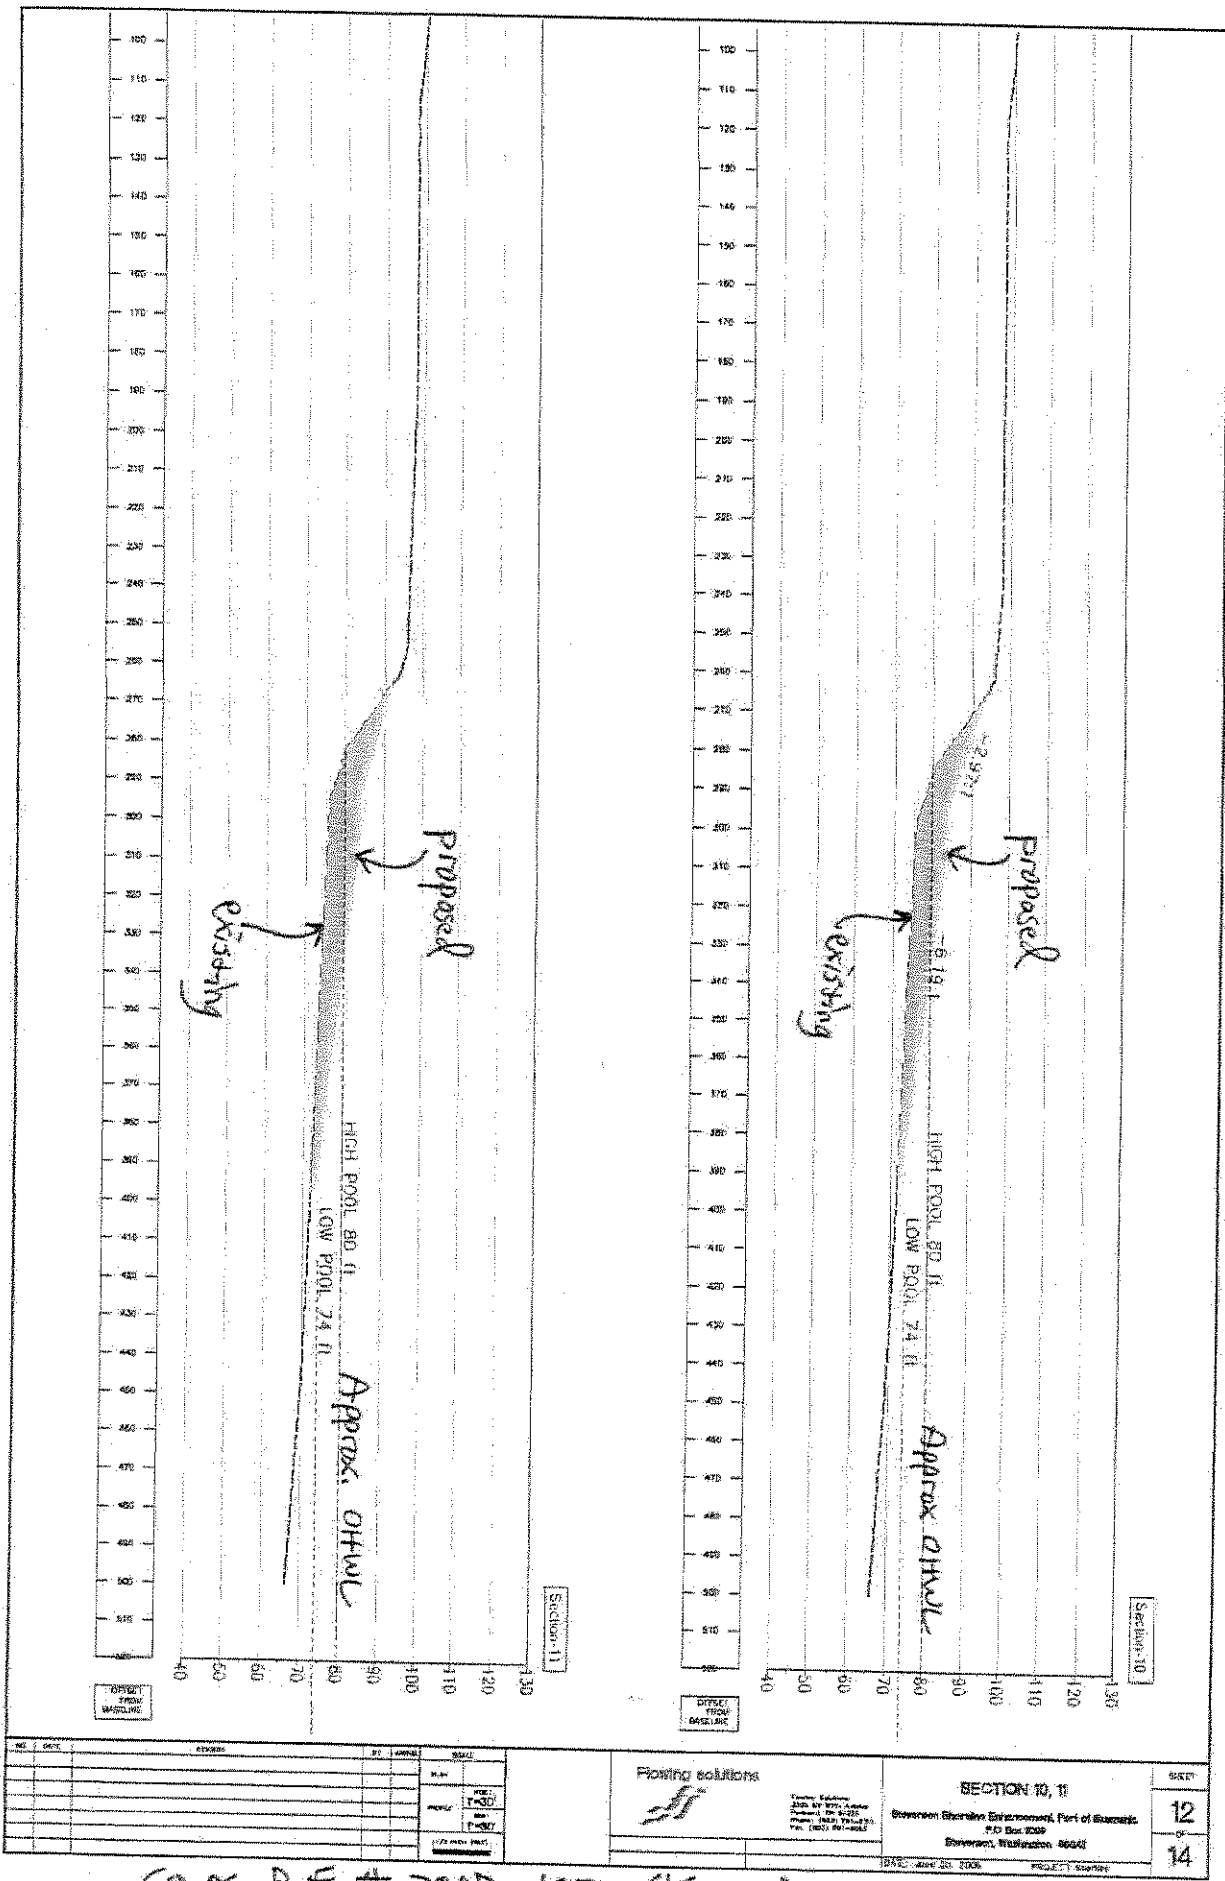

NO.	DATE	REVISION	BY	APPROVED	SCALE	Flowing solutions Project Engineer John W. Jones Project Engineer John W. Jones Project Engineer John W. Jones	SECTION 10, 11 Overman Channel Enhancement, Port of Skamania 410 East 200th Skamania, Washington 98581	SHEET 12 OF 14

Corps Ref. # 2007-192 Skamania County

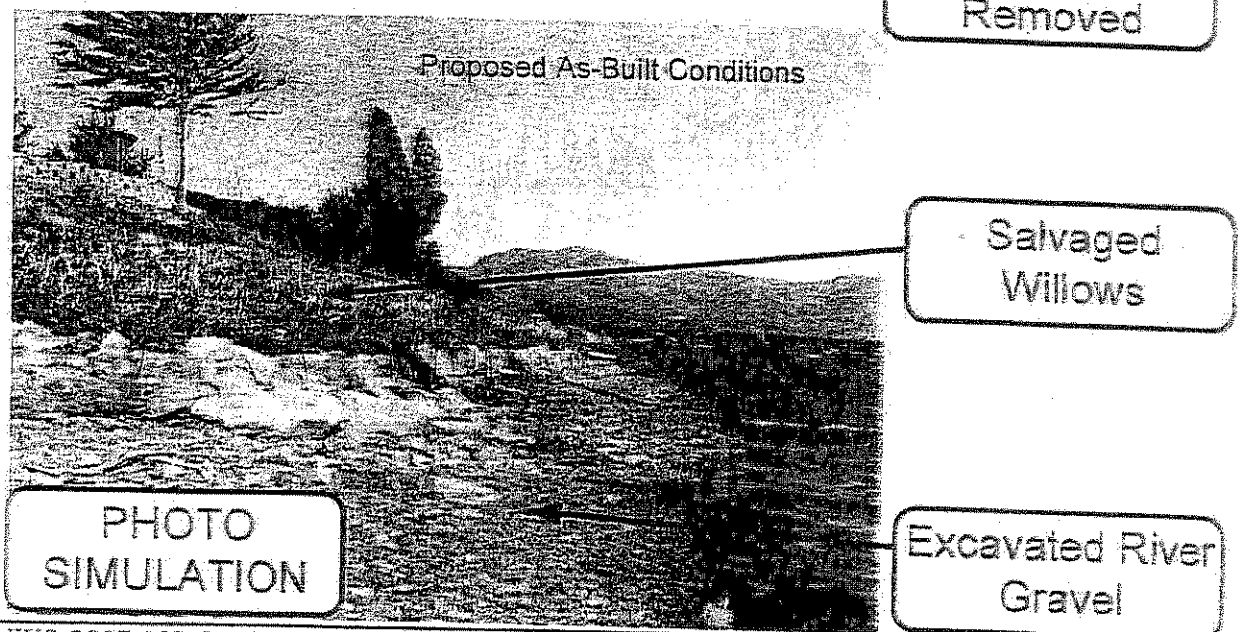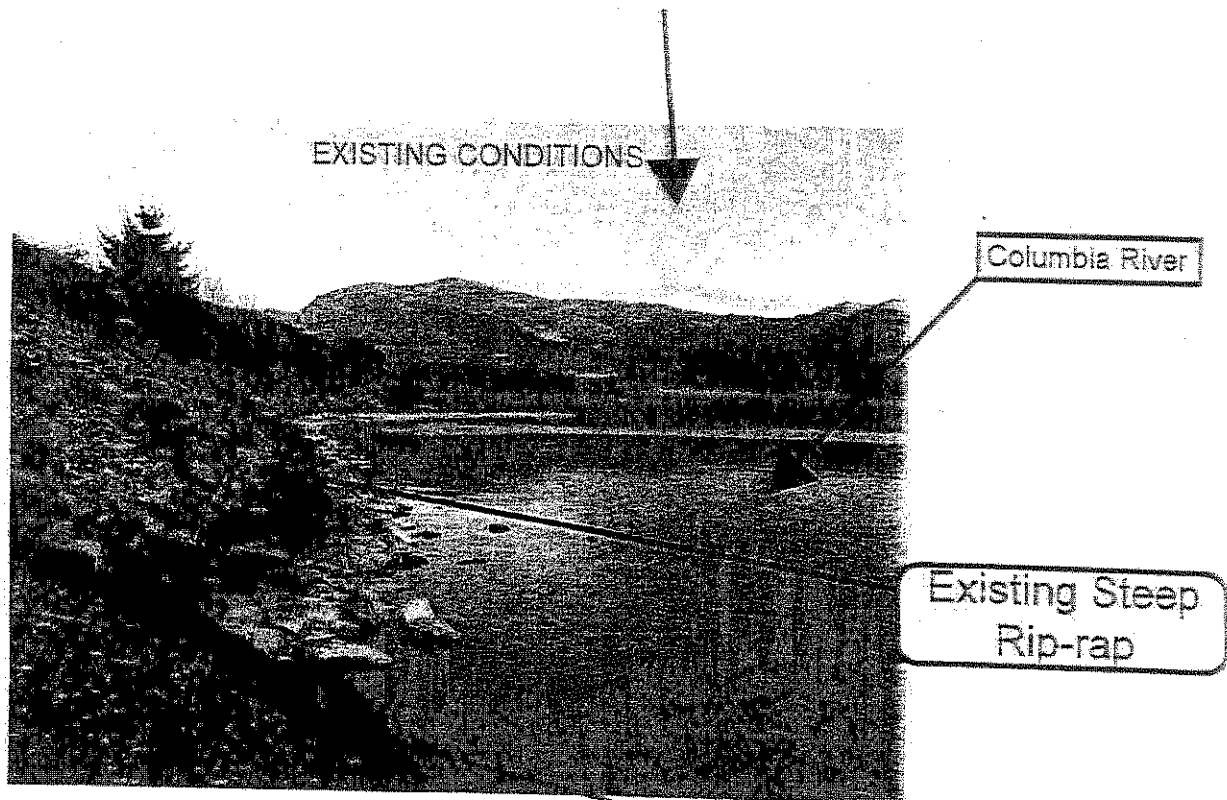

REF: NWS-2007-192-ORS

Skamania County Public Works

In: Rock Creek

At: Stevenson, WA

12 April 2007

Proposed Mitigation
Typical 2 of 2

